PARTIAL ROOF REPLACEMENT AT:

BEECHER ROAD ELEMENTARY SCHOOL

40 BEECHER ROAD.
WOODBRIDGE, CONNECTICUT 06525

PROJECT LOCATION:



DRAWING LIST

COVER SHEET

ARCHITECTURAL:

1 CODE INFORMATION
1 OVERALL ROOF PLAN
2 ROOF PLAN PART "1"
3 ROOF DETAILS

SILVER PETRUCELLI & ASSOC.
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ARCHITECT



SILVER PETRUCELLI + ASSOCIATES

3190 WHITNEY AVENUE HAMDEN CT 06518 311 STATE STREET NEW LONDON CT 06320 203 230 9007 silverpetrucelli.com BUILDING INSPECTOR FIRE M

OFFICIALS:

FIRE MARSHAL


SANITARIAN/ HEALTH INSPECTOR

ADA/504 COORDINATOR

CONSTRUCTION DOCUMENT SUBMISSION: 02/14/2024

STATE PROJECT 167-0026 RR

CODE INFORMATION	12. MINIMUM PLUMBING FIXTURE COUNT (I.P.C. CHAPTER 4) FOR EACH TYPE OF OCCUPANCY PER ENTIRE FACILITY	SYMBOL LEGEND - PLAN SECTION DETAIL OR ELEVATION- SHEET NUMBER			
	GROUP "A3" OCCUPANCY (DESIGN LOAD = NA) REQUIRED PROVIDED	- PLAN SECTION DETAIL OR ELEVATION- SHEET NUMBER SL INDICATES SLOPE DIRECTION OF SLOPED STRUCTURAL DECK.			
DATE OF ORIGINAL CONSTRUCTION DATE OF ADDITION	W/C MALE NA NA NA NA	——————————————————————————————————————			
	LAVS NA NA	 QX - INDICATES SLOPE DIRECTION & INDICATES EXISTING ROOF PITCH. NIC NOT IN CONTRACT SCOPE 			
1. GROUP CLASSIFICATION (CHAPTER 3) (PRIMARY)E-EDUCATIONAL	D/F NA NA	- WALKWAY PADS. SEE CONSTRUCTION NOTE #2			
(INCIDENTAL)	W/C UNISEX NA NA NA	ERD EXISTING ROOF DRAIN TO BE REMOVED. SEE DEMOLITION NOTES. NRD NEW ROOF DRAIN TO BE INSTALLED. SEE DETAIL A/A3			
2. CONSTRUCTION TYPE (CHAPTER 6) MINIMUM TYPE REQUIRED	GROUP "E" OCCUPANCY, (DESIGN LOAD = NA)	SRD SECONDARY OVERFLOW ROOF DRAIN. SEE DETAIL B/A3			
ACTUAL TYPE PROVIDED (EXISTING)	W/C NA NA	CB METAL SCUPPER W/ COLLECTION BOX. SEE DETAIL C/A3			
(NEW) ZB	LAVS NA NA	VS EXISTING VENT STACK. SEE DETAIL E/A3 PP PITCH POCKET. SEE DETAIL F/A3			
3. BUILDING HEIGHT (CHAPTER 5) ALLOWABLE HEIGHT (STORY/FEET) 3/75'-0"	D/F NA NA (TOTAL DESIGN LOAD FOR ENTIRE FACILITY = NA)	RH ROOF HATCH. SEE DETAIL G & H/A3			
ACTUAL HEIGHT (STORY/FEET)	YES NO 13. ENTIRE BUILDINGS SPRINKLERED X	SK SKYLIGHT. SEE DETAIL J/A3 MS NEW METAL STAIRCASE. SEE DETAIL K/A3			
	YES NO 14. THRESHOLD BUILDING CONDITIONS X	FU EXISTING ROOF TOP FAN UNIT. SEE DETAIL L/A3			
4. BUILDING AREA (CHAPTER 5) A) BUILDING AREA (FIRST)	14. THRESHOLD BUILDING CONDITIONS 15. CODES TO WHICH THIS PROJECT WAS DESIGNED	MU EXISTING MECHANICAL UNIT. SEE DETAIL M/A3			
EXISTING CONSTRUCTION	State Building Code 2021 IBC CTSBC/2022 AMEND.	RTU-1 EXISTING ROOF TOP MECHANICAL UNIT. SEE DETAIL N/A3 RTU-2 EXISTING ROOF TOP MECHANICAL UNIT. SEE CONSTRUCTION NOTE #3			
TOTAL FLOOR	State Mechanical Code 2017 ICC State Plumbing Code 2015 IPC	DS METAL DOWNSPOUT. SEE CONSTRUCTION NOTE #4			
B) BUILDING AREA (SECOND) EXISTING CONSTRUCTION 0 sq.ft.	State Energy Conservation Code 2015 IECC State Electrical Code 2020 NFPA 70	DW EXISTING ROOF TOP DUCT WORK. SEE CONSTRUCTION NOTE #5 GP EXISTING GAS PIPING. SEE CONSTRUCTION NOTE #6			
NEW CONSTRUCTION 0 sq.ft.	State Health Code MOST CURRENT	EC EXISTING ELECTRICAL CONDUIT. SEE CONSTRUCTION NOTE #7			
TOTAL FLOOR L sq.ft.	OSHA MOST CURRENT Section 504 CURRENT	AD ABANDONED METAL DUNNAGE. SEE DEMOLITION NOTE #5			
TOTAL (ALL FLOORS) 152,355 sq.ft.	ADA MOST CURRENT ANSI 117 1 MOST CURRENT	AM ABANDONED MECHANICAL CURB., SEE DEMOLITION NOTE #6			
	,	GENERAL NOTES 1. ALL FLAT ROOFS TO RECEIVE ‡" PER FOOT TAPERED RIGID INSULATION MINIMUM UNLESS OTHERWISE NOTED.			
5. AREA MODIFICATIONS TO TABLE 503 (FOR EACH SEPARATE BUILDING AS DEFINED BY FIRE WALLS AND/OR EXTERIOR WALLS) NA	16. BUILDING AREAS FOR GRANT CALCULATION (ENTIRE FACILITY) (MEASURED TO INSIDE FACE OF EXTERIOR WALLS)	2. FIELD VERIFY ALL DIMENSIONS & PERFORM TEST CUTS AT EACH ROOF PRIOR TO THE BID.			
NA 6. CASE 1 - SINGLE OCCUPANCY OR NONSEPARATED USES (302.3.1)	(MEASURED TO INSIDE FACE OF EXTERIOR WALLS) EXISTING UNRENOVATED CONSTRUCTION 0 SQ.FT.	 ALL MATERIALS ARE NEW UNLESS OTHERWISE NOTED "EXISTING". ALL WOOD BLOCKING, PLYWOOD & NAILERS TO BE PRESSURE TREATED. (P.T.) 			
(ALLOWABLE AREA 506.4) NA	EXISTING RENOVATED CONSTRUCTION 0 SQ.FT.	4. ALL WOOD BLOCKING, PLYWOOD & NAILERS TO BE PRESSURE TREATED. (P.T.) 5. ALL WOOD BLOCKING INDICATED IN DETAILS ARE TO BE ANCHORED TO THE EXISTING STRUCTURE.			
7. CASE 2 - MIXED OCCUPANCY SEPARATED USES (302.3.2) (ALLOWABLE AREA 506.4)	TOTAL EXISTING CONSTRUCTION 34,860 SQ.FT.	6. ALL MEMBRANE FLASHING INDICATED IS TO EXTEND A MINIMUM OF 8". (VERTICAL OR HORIZONTAL)			
NA	TOTAL NEW CONSTRUCTION SQ.FT.	7. CONTRACTOR IS TO SURVEY THE EXISTING ROOF DECKS W/A LEVEL (AFTER DEMOLITION) TO VERIFY THE SLOPES INDICATED ON PLAN ARE ACCURATE. NOTIFY ARCHITECT IMMEDIATELY OF ANY DISCREPANCIES PRIOR TO PERFORMING ANY ADDITIONAL ROOFING OPERATIONS.			
8. FIRE-RESISTANCE RATED REQUIREMENTS FOR BUILDING ELEMENTS (TABLE 601, SEE CODE PLANS FOR SPECIFIC DESIGNATIONS)	OPEN AREAS (NOT INCLUDED IN TOTAL FACILITY)	CONTRACTOR IS TO INSPECT THE UNDERSIDE OF ALL ROOF DECKS PRIOR TO ROOFING OPERATIONS TO ENSURE THAT NO INTERIOR MATERIALS, EQUIPMENT, FINISHES OR OBJECTS WILL BE PIERCED OR DAMAGED.			
1 STRUCTURAL FRAME: INCLUDING	NASQ.FT.	9. CONTRACTOR ASSUMES ALL RESPONSIBILITY DURING PROJECT & WILL REPLACE ANY & ALL DAMAGED EQUIPMENT W/NO ADDITIONAL COST TO OWNER.			
COLUMNS, GIRDERS, TRUSSES 0 Hr(s) 2 BEARING WALLS:	17. TOTAL CONSTRUCTED BUILDING AREA (OUTSIDE FACE OF EXTERIOR WALLS NA SQ.FT.	10. SITE AREAS DISTURBED SHALL BE CLEANED & RE-LEVELED, W/LAWN AREAS MAGNETICALLY RAKED TO			
EXTERIOR (TABLE 602)	INCLUDING OPEN AREAS ABOVE)	REMOVE ANY METAL DEBRIS & RE-SEEDED AS REQUIRED TO MATCH ADJACENT CONDITIONS. 11. CONTRACTOR ASSUMES ALL RESPONSIBILITY FOR CLEAN UP OF ROOFING MATERIALS & DEBRIS THAT			
3 NONBEARING WALLS & PARTITIONS EXTERIOR (TABLE 602) 0/1 Hr(s)	FIRE SAFETY CODE DATA: 1. CLASSIFICATION OF OCCUPANCY EDUCATIONAL/ASSEMBLY	PENETRATES THE INTERIOR ENVELOPE OF THE BUILDING W/NO ADDITIONAL COST TO THE OWNER. 12. SNAKE/CLEAN OUT ALL EXISTING VERTICAL & HORIZONTAL LEADERS OUT TO NEAREST MANHOLE OUTSIDE OF			
4 NONBEARING WALLS & PARTITIONS INTERIOR 0 Hr(s)	1. CLASSIFICATION OF OCCUPANCY EDUCATIONAL/ASSEMBLY 2. MINIMUM CONSTRUCTION REQUIRED 2B	BUILDING.			
5 FLOOR CONSTRUCTION (INCLUDING SUPPORTING BEAMS & JOISTS) 0 Hr(s)	ACTUAL CONSTRUCTION PROVIDED 2A 3. NOTIFICATION / ALARMS X NO	13. ALL CRICKETS ARE TO BE SLOPED @ A MINIMUM OF ½" PER FOOT & COORDINATE CRICKETS AROUND EXIST. HVAC UNITS AS REQUIRED TO AVOID PONDING.			
6 ROOF CONSTRUCTION (INCLUDING SUPPORTING BEAMS & JOISTS) 0 Hr(s)	(CFSC 2005, NFPA 72, NATIONAL FIRE ALARM CODE 2002)	14. CONTRACTOR IS RESPONSIBLE FOR THE REMOVAL & RE-INSTALLATION OF ALL HVAC UNITS INCLUDING ANY ELECTRICAL OR MECHANICAL CONNECTIONS. THIS MAY INCLUDE THE EXTENSION OF EXISTING ELECTRICAL & DUCTWORK SYSTEMS TO ACCOMMODATE NEW MECHANICAL UNIT CURBING & NEW ROOFING SYSTEM.			
9. OCCUPANCY LOAD	(CFSC 2005, NFPA 72, NATIONAL FIRE ALARM CODE 2002)	15. SNAKE/CLEAN OUT ALL EXISTING VENT STACKS BEFORE THE INSTALLATION OF METAL SLEEVE.			
DESIGN TOTAL FOR BASEMENT NA TOTAL EXIT CAPACITY FOR BASEMENT NA	5. EXTINGUISHMENT REQUIREMENTS (NFPA 13, 2002)	16. ALL DRAIN PIPING IS INSULATED ABOVE THE CEILINGS. THE EXACT ROUTE WILL BE DETERMINED IN THE FIELD. MAKE MINOR ADJUSTMENT IN THE ROUTE AT NO ADDITIONAL COST TO OWNER.			
DESIGN TOTAL FOR FIRST FLOOR NA	MEANS OF EGRESS	17. NEW ROOF INSULATION TO BE A MINIMUM OF R-30 AT ALL NEW ROOF DRAINS AND/OR THE LOW POINTS OF THE ROOF AREAS.			
TOTAL EXIT CAPACITY FOR FIRST FLOOR NA DESIGN TOTAL FOR BUILDING NA	MAXIMUM FLOOR AREA ALLOWANCES PER OCCUPANT IBC TABLE 1004.1.2	18. ALL ANTENNAE, CONDUITS & ANY OTHER OBJECTS TO REMAIN AFFECTED BY SCOPE OF WORK, TO BE REMOVED & REINSTALLED.			
TOTAL EXIT CAPACITY FOR BUILDING NA	USE FLOOR AREA IN S.F. PER OCCUPANT 1. CLASSROOMS <u>20 S.F. NET</u>	DEMOLITION NOTES ⊗→			
10. MODIFICATIONS APPROVED APPROVED	2. SHOPS & VOCATIONAL 50 S.F. NET	1. REMOVE EXISTING ROOFING MEMBRANE, 1-1/2" OF RIGID INSULATION DOWN TO EXISTING METAL DECK.			
NOT APPROVED APPROVED	3. ASSEMBLY WITHOUT FIXED SEATS 7 S.F. NET	2. REMOVE EXISTING ROOFING MEMBRANE, 1-1/2" BASE LAYER OF POLYISO & $\frac{1}{4}$ " TAPERED INSULATION SYSTEM DOWN TO EXISTING METAL DECK.			
NOT	TABLES AND CHAIRS 15 S.F. NET 4. PLATFORMS 15 S.F. NET	3. REMOVE ALL PERIMETER METAL FLASHING WITHIN SCOPE OF WORK.			
APPROVED APPROVED	4. PLATFORMS <u>15 S.F. NET</u> 5. LIBRARY	 REMOVE EXISTING ROOF DRAINS & SUMP. REMOVE & DISPOSE OF EXISTING METAL DUNNAGE. 			
	READING ROOMS 50 S.F. NET STACK AREA 100 S.F. GROSS	6. REMOVE EXISTING ABANDONED MECHANICAL UNIT CURB. PATCH EXISTING METAL DECK TO MATCH EXISTING. SEE DETAIL Z/A3			
	6. LOCKER ROOMS <u>50 S.F. GROSS</u>	CONSTRUCTION NOTES (X)→			
11. ACCESSIBLE BUILDING DESIGNATED NON DESIGNATED	7. MECHANICAL AREAS 300 S.F. GROSS 8. STORAGE 300 S.F. GROSS	CONTRACTOR TO PROVIDE A SPECIFIED QUANTITY OF EXISTING DECK REPAIR & REPLACEMENT. SEE PROJECT MANUAL.			
	8. STORAGE 300 S.F. GROSS 9. BUSINESS AREAS 100 S.F. GROSS	2. WALKWAY PADS TO BE INSTALLED PER MANUFACTURER'S RECOMMENDATION. SEE PROJECT MANUAL FOR ADDITIONAL INFORMATION. COORDINATE & FINALIZE EXACT ROUTE W/ OWNER & ARCHITECT.			
	10. Courtyards 15 S.F. NET MAXIMUM LENGTH OF EXIT TRAVEL	3. EXISTING ROOFTOP MECHANICAL UNIT. RAISE ENTIRE UNIT MIN. 8" ABOVE HIGH POINT OF NEW ROOF INSULATION. EXTEND ALL DUCTWORK & ELECTRICAL WIRING. SEE DETAIL P/A3 & PROJECT MANUAL.			
	1. I.B.C. TABLE 1015.1 <u>250 feet</u>	4. NEW METAL DOWNSPOUT LOCATION, CONNECT TO EXIST UNDERGROUND PIPING, OR PROVIDE NEW CONCRETE			
		SPLASH BLOCK IF NO UNDERGROUND PIPING EXISTS. 5. EXISTING MECHANICAL UNIT DUCT WORK TO REMAIN, MODIFY ALL STAND-OFFS TO ACCOMMODATE NEW ROOF			
		INSULATION HEIGHT. SEE DETAIL Q/A3 & PROJECT MANUAL. 6. EXISTING GAS PIPING TO BE DISCONNECTED & PURGED. RAISE EXISTING GAS PIPING AS REQUIRED TO			
		ACCOMMODATE NEW ROOFING INSULATION HEIGHTS. PROVIDE NEW PIPING EXTENSIONS, JOINTS, FITTINGS & RECONNECT TO EXISTING GAS MAIN. INSTALL ALL EXIST. & NEW GAS PIPING ON NEW PIPE CURBS 24" O.C. PRIME & PAINT ALL EXISTING & NEW GAS PIPING. SEE DETAIL W/A3 & PROJECT MANUAL.			
		7. EXISTING ELECTRICAL CONDUIT TO BE DISCONNECTED & RAISED TO ACCOMMODATE NEW ROOF INSULATION HEIGHTS. REMOVE WIRE/CONDUIT & DISPOSE OF, INSTALL NEW CONDUIT & WIRING IN EXIST LOCATIONS &			
		REPLACE ALL EXISTING JUNCTION BOXES TO MATCH EXISTING. EXTEND CONDUIT & WIRING AS REQUIRED TO ACCOMMODATE NEW ROOF HEIGHTS & ADD NEW JUNCTION BOXES AS REQUIRED. SEE DETAIL W/A3 & PROJECT MANUAL.			
		ROOF AREAS ROOF ASSEMBLY			
		ROOF "A" 6,400 SF. OUTSIDE AIR 0.17 ROOF "B" 6,960 SF. ROOF MEMBRANE 0.33			
		ROOF "C" 21,500 SF. COVERBOARD 2.20 5" POLYISO INSUL. 29.7 EXISTING DECK 1.23			
		THIS AREA IS APPROXIMATE- V.I.F. IECC CODE REQUIREMENT R-VALUE MIN. R-30 INSIDE AIR 0.61			
		CONNECTICUT ZONE 2B CBSC REQUIREMENT: R-30 -U.0333 CODE INFORMATION R-VALUE TOTAL 34.24			
		USE GROUP: E CONSTRUCTION CLASS: 2B			
		RISK CATEGORY #3 ULTIMATE DESIGN WIND SPEED: 135 MPH NOMINAL DESIGN WIND SPEED: 105 MPH			
		FACTORY MUTUAL ENGINEERING & RESEARCH			
		CORPORATION (FM): ROOF ASSEMBLY CLASSIFICATION OF NON-COMBUSTIBLE CONSTRUCTION, WIND UPLIFT REQUIREMENT			
		OF I-60 FOR FIELD, I-75 FOR PERIMETER AND I-110 FOR CORNERS, IN ACCORDANCE WITH FM PROPERTY LOSS PREVENTION DATA SHEETS			
		1-28.			
Project Title: PARTIAL ROOF REPLACEMENT AT:		SILVER PETRUCELLI + ASSOCIATES	Description: Date: Revised By:	Drawing Title:	Date: Drawing Number: 02/14/2024
BEECHER ROAD ELEMENTARY SCHOOL				CODE INFORMATION	Scale: NONE
40 BEECHER ROAD.		3190 WHITNEY AVENUE HAMDEN CT 06518 311 STATE STREET NEW LONDON CT 06320			Drawn By:
WOODBRIDGE, CONNECTICUT 06525		203 230 9007 silverpetrucelli.com		STATE PROJECT 167-0026 RR	K.LINSLEY Project Number: 23.108
				1	_000

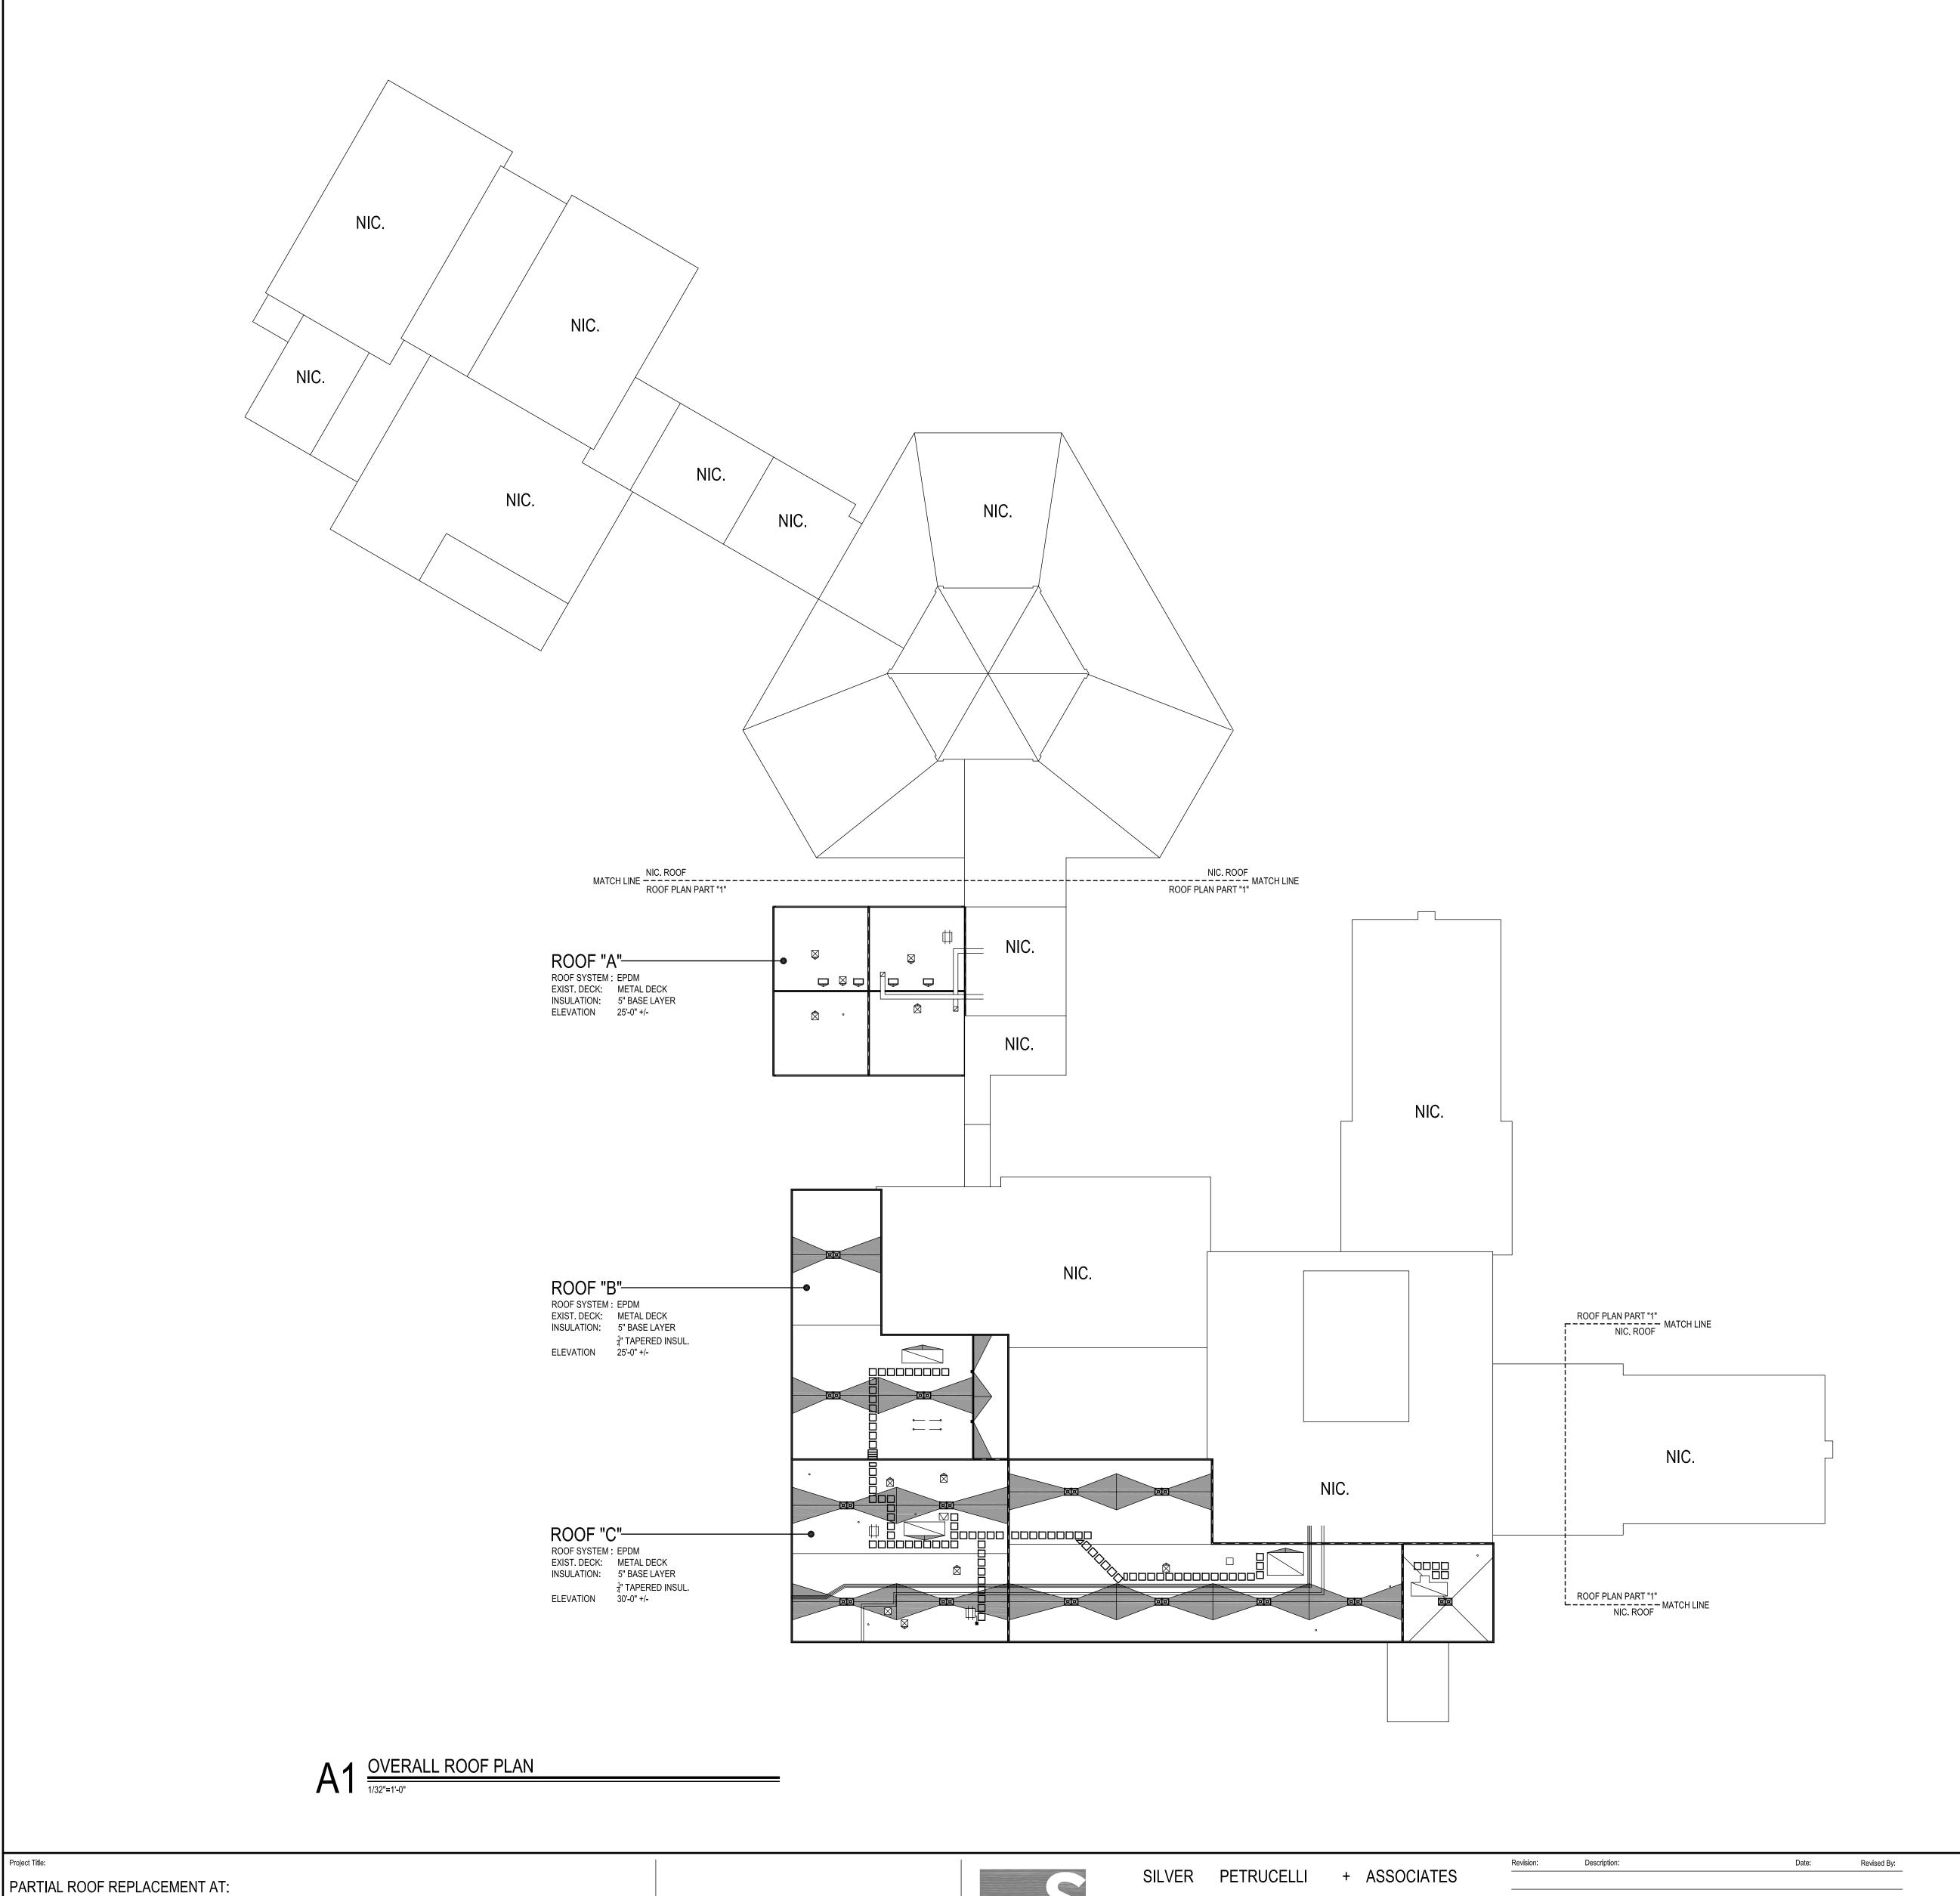

SYMBOL LEGEND

- PLAN SECTION DETAIL OR ELEVATION- SHEET NUMBER

INDICATES SLOPE DIRECTION OF SLOPED STRUCTURAL DECK.



- TAPERED INSULATION CRICKET SLOPED @ ½" PER FOOT

INDICATES SLOPE DIRECTION & INDICATES EXISTING ROOF PITCH. NIC. - NOT IN CONTRACT SCOPE

WALKWAY PADS. SEE CONSTRUCTION NOTE #2

ERD. - EXISTING ROOF DRAIN TO BE REMOVED. SEE DEMOLITION NOTES.

NRD. - NEW ROOF DRAIN TO BE INSTALLED. SEE DETAIL A/A3

SRD. - SECONDARY OVERFLOW ROOF DRAIN. SEE DETAIL B/A3

CB. - METAL SCUPPER W/ COLLECTION BOX. SEE DETAIL C/A3

VS. - EXISTING VENT STACK. SEE DETAIL E/A3

PP. - PITCH POCKET. SEE DETAIL F/A3

RH. - ROOF HATCH. SEE DETAIL G & H/A3

SK. - SKYLIGHT. SEE DETAIL J/A3

MS. - NEW METAL STAIRCASE. SEE DETAIL K/A3

FU. - EXISTING ROOF TOP FAN UNIT. SEE DETAIL L/A3

MU. - EXISTING MECHANICAL UNIT. SEE DETAIL M/A3

RTU-1. - EXISTING ROOF TOP MECHANICAL UNIT. SEE DETAIL N/A3

RTU-2. - EXISTING ROOF TOP MECHANICAL UNIT. SEE CONSTRUCTION NOTE #3

DS. - METAL DOWNSPOUT. SEE CONSTRUCTION NOTE #4

DW. - EXISTING ROOF TOP DUCT WORK. SEE CONSTRUCTION NOTE #5

GP. - EXISTING GAS PIPING. SEE CONSTRUCTION NOTE #6

EC. - EXISTING ELECTRICAL CONDUIT. SEE CONSTRUCTION NOTE #7

AD. - ABANDONED METAL DUNNAGE. SEE DEMOLITION NOTE #5

AM. - ABANDONED MECHANICAL CURB., SEE DEMOLITION NOTE #6

GENERAL NOTES

ALL FLAT ROOFS TO RECEIVE 4" PER FOOT TAPERED RIGID INSULATION MINIMUM UNLESS OTHERWISE NOTED.

2. FIELD VERIFY ALL DIMENSIONS & PERFORM TEST CUTS AT EACH ROOF PRIOR TO THE BID.

3. ALL MATERIALS ARE NEW UNLESS OTHERWISE NOTED "EXISTING".

4. ALL WOOD BLOCKING, PLYWOOD & NAILERS TO BE PRESSURE TREATED. (P.T.)

5. ALL WOOD BLOCKING INDICATED IN DETAILS ARE TO BE ANCHORED TO THE EXISTING STRUCTURE.

6. ALL MEMBRANE FLASHING INDICATED IS TO EXTEND A MINIMUM OF 8". (VERTICAL OR HORIZONTAL)

CONTRACTOR IS TO SURVEY THE EXISTING ROOF DECKS W/A LEVEL (AFTER DEMOLITION) TO VERIFY THE SLOPES INDICATED ON PLAN ARE ACCURATE. NOTIFY ARCHITECT IMMEDIATELY OF ANY DISCREPANCIES PRIOR TO PERFORMING ANY ADDITIONAL ROOFING OPERATIONS.

CONTRACTOR IS TO INSPECT THE UNDERSIDE OF ALL ROOF DECKS PRIOR TO ROOFING OPERATIONS TO ENSURE THAT NO INTERIOR MATERIALS, EQUIPMENT, FINISHES OR OBJECTS WILL BE PIERCED OR DAMAGED.

9. CONTRACTOR ASSUMES ALL RESPONSIBILITY DURING PROJECT & WILL REPLACE ANY & ALL DAMAGED EQUIPMENT W/NO ADDITIONAL COST TO OWNER.

10. SITE AREAS DISTURBED SHALL BE CLEANED & RE-LEVELED, W/LAWN AREAS MAGNETICALLY RAKED TO REMOVE ANY METAL DEBRIS & RE-SEEDED AS REQUIRED TO MATCH ADJACENT CONDITIONS.

. CONTRACTOR ASSUMES ALL RESPONSIBILITY FOR CLEAN UP OF ROOFING MATERIALS & DEBRIS THAT PENETRATES THE INTERIOR ENVELOPE OF THE BUILDING W/NO ADDITIONAL COST TO THE OWNER.

12. SNAKE/CLEAN OUT ALL EXISTING VERTICAL & HORIZONTAL LEADERS OUT TO NEAREST MANHOLE OUTSIDE OF

13. ALL CRICKETS ARE TO BE SLOPED @ A MINIMUM OF $\frac{1}{2}$ " PER FOOT & COORDINATE CRICKETS AROUND EXIST. HVAC UNITS AS REQUIRED TO AVOID PONDING.

14. CONTRACTOR IS RESPONSIBLE FOR THE REMOVAL & RE-INSTALLATION OF ALL HVAC UNITS INCLUDING ANY ELECTRICAL OR MECHANICAL CONNECTIONS. THIS MAY INCLUDE THE EXTENSION OF EXISTING ELECTRICAL & DUCTWORK SYSTEMS TO ACCOMMODATE NEW MECHANICAL UNIT CURBING & NEW ROOFING SYSTEM.

15. SNAKE/CLEAN OUT ALL EXISTING VENT STACKS BEFORE THE INSTALLATION OF METAL SLEEVE.

16. ALL DRAIN PIPING IS INSULATED ABOVE THE CEILINGS. THE EXACT ROUTE WILL BE DETERMINED IN THE FIELD.

MAKE MINOR ADJUSTMENT IN THE ROUTE AT NO ADDITIONAL COST TO OWNER. 7. NEW ROOF INSULATION TO BE A MINIMUM OF R-30 AT ALL NEW ROOF DRAINS AND/OR THE LOW POINTS OF THE

18. ALL ANTENNAE, CONDUITS & ANY OTHER OBJECTS TO REMAIN AFFECTED BY SCOPE OF WORK, TO BE REMOVED & REINSTALLED.

DEMOLITION NOTES ⊗→

REMOVE EXISTING ROOFING MEMBRANE, 1-1/2" OF RIGID INSULATION DOWN TO EXISTING METAL DECK.

REMOVE EXISTING ROOFING MEMBRANE, 1-1/2" BASE LAYER OF POLYISO & 4" TAPERED INSULATION SYSTEM DOWN TO EXISTING METAL DECK.

REMOVE ALL PERIMETER METAL FLASHING WITHIN SCOPE OF WORK.

REMOVE EXISTING ROOF DRAINS & SUMP.

REMOVE & DISPOSE OF EXISTING METAL DUNNAGE.

REMOVE EXISTING ABANDONED MECHANICAL UNIT CURB. PATCH EXISTING METAL DECK TO MATCH EXISTING. SEE DETAIL Z/A3

CONSTRUCTION NOTES \times

CONTRACTOR TO PROVIDE A SPECIFIED QUANTITY OF EXISTING DECK REPAIR & REPLACEMENT. SEE PROJECT

WALKWAY PADS TO BE INSTALLED PER MANUFACTURER'S RECOMMENDATION. SEE PROJECT MANUAL FOR ADDITIONAL INFORMATION. COORDINATE & FINALIZE EXACT ROUTE W/ OWNER & ARCHITECT.

EXISTING ROOFTOP MECHANICAL UNIT. RAISE ENTIRE UNIT MIN. 8" ABOVE HIGH POINT OF NEW ROOF INSULATION. EXTEND ALL DUCTWORK & ELECTRICAL WIRING. SEE DETAIL P/A3 & PROJECT MANUAL.

NEW METAL DOWNSPOUT LOCATION, CONNECT TO EXIST UNDERGROUND PIPING, OR PROVIDE NEW CONCRETE SPLASH BLOCK IF NO UNDERGROUND PIPING EXISTS.

INSULATION HEIGHT. SEE DETAIL Q/A3 & PROJECT MANUAL. EXISTING GAS PIPING TO BE DISCONNECTED & PURGED. RAISE EXISTING GAS PIPING AS REQUIRED TO

EXISTING MECHANICAL UNIT DUCT WORK TO REMAIN, MODIFY ALL STAND-OFFS TO ACCOMMODATE NEW ROOF

ACCOMMODATE NEW ROOFING INSULATION HEIGHTS. PROVIDE NEW PIPING EXTENSIONS, JOINTS, FITTINGS & RECONNECT TO EXISTING GAS MAIN. INSTALL ALL EXIST. & NEW GAS PIPING ON NEW PIPE CURBS 24" O.C.

PRIME & PAINT ALL EXISTING & NEW GAS PIPING. SEE DETAIL W/A3 & PROJECT MANUAL.

EXISTING ELECTRICAL CONDUIT TO BE DISCONNECTED & RAISED TO ACCOMMODATE NEW ROOF INSULATION HEIGHTS. REMOVE WIRE/CONDUIT & DISPOSE OF, INSTALL NEW CONDUIT & WIRING IN EXIST LOCATIONS & REPLACE ALL EXISTING JUNCTION BOXES TO MATCH EXISTING. EXTEND CONDUIT & WIRING AS REQUIRED TO ACCOMMODATE NEW ROOF HEIGHTS & ADD NEW JUNCTION BOXES AS REQUIRED. SEE DETAIL W/A3 & PROJECT

ROOF "B" 6,960 SF. ROOF "C" 21,500 SF. TOTAL ROOF AREAS: 34,860 SF. THIS AREA IS APPROXIMATE- V.I.F. IECC CODE REQUIREMENT R-VALUE MIN. R-30 CONNECTICUT ZONE 2B CBSC REQUIREMENT : R-30 -U.0333 CODE INFORMATION

ROOF AREAS

ROOF "A" 6,400

USE GROUP: E CONSTRUCTION CLASS: 2B RISK CATEGORY #3

NOMINAL DESIGN WIND SPEED: 105 MPH FACTORY MUTUAL ENGINEERING & RESEARCH CORPORATION (FM): ROOF ASSEMBLY CLASSIFICATION OF NON-COMBUSTIBLE CONSTRUCTION, WIND UPLIFT REQUIREMENT OF I-60 FOR FIELD, I-75 FOR PERIMETER AND I-110 FOR CORNERS, IN ACCORDANCE WITH FM PROPERTY LOSS PREVENTION DATA SHEETS

COVERBOARD 2.20 5" POLYISO INSUL. EXISTING DECK 1.23 INSIDE AIR 0.61 R-VALUE TOTAL ULTIMATE DESIGN WIND SPEED: 135 MPH

0.33

ROOF ASSEMBLY

ROOF MEMBRANE

4'-0" 8'-0" 12'-0" GRAPHIC SCALE - 1/8" = 1'-0"

Drawing Number:

23.108

OVERALL ROOF PLAN 1/32"=1'-0" Drawn By: K.LINSLEY Project Number:

3190 WHITNEY AVENUE HAMDEN 311 STATE STREET NEW LONDON silverpetrucelli.com

STATE PROJECT 167-0026 RR

BEECHER ROAD ELEMENTARY SCHOOL

