#### **DRAWING INDEX** SHEET 1: SPECIFICATIONS AND CONDITIONS

SHEET 2: FLOOR PLAN, FLOOR PLAN LEGEND

SHEET 3: DOOR & WINDOW SCHEDULE

SHEET 4: ELEVATIONS

SHEET 5: ELECTRICAL PLAN, ELECTRICAL LEGEND, **ELECTRICAL CALCS AND ELECTRICAL NOTES** 

SHEET 6: ELECTRICAL PANELS

SHEET 7: HVAC PLAN SHEET 8: REFLECTED CEILING PLAN & PLYWOOD BEAM

SHEET 9: BUILDING CROSS-SECTION

SHEET 10: PLUMBING SCHEMATICS SHEET 11: SUGGESTED BLOCKING PLAN

# DEALER:

# PACIFIC MOBILE STRUCTURES

# PROJECT:

# DO-1130-2024 PMS WESTHOFF, TX CLASSROOM 154 X 64 (60) DO-1130

WESTHOFF, TX

Insulation:

Wall Covering 2:

### FRAME / CHASSIS:

Frame Type: Perimeter (11) EA Quantity: (10x)146012 Size: (1x) 126012

C-channel (C12x20.7) perimeter with C-purlin crossmembers at 16 in. O.C. Type:

(C-Purlins: 1/2 x 2 1/2 x 8 x 2 1/2 x 1/2 x 14 ga. (50 KSI minimum).

Five 6000# rated with (3) brake (2) tag (OVERSLUNG) (Module A,B,C,D,E,F,H,I,J,K) Axles:

Six 6000# rated with (3) brake (3) tag (OVERSLUNG) (Module G) Axles:

Hitch: Detachable underslung

### **FLOOR CONSTRUCTION:**

2X3 #2 #2 SYP equal or better parallel with C-Purlins. Attach sleeper to steel perimeter

16 in. O.C. Joist:

Floor:

Single layer 3/4 in. T&G Sturd-I-Floor plywood. Hold back decking (2 1/4) inches at each side

R-30 unfaced fiberglass batt (True Width) Insulation

channel and C-Purlins

29GA. U-Panel Bottom Board Bottom:

Floor Covering Type 1

8463 SF 1/8in. commercial grade tile. Tile to be Checkboard (YES or NO) and

50% Offset (YES or NO). Hold back tile (4 1/2) inches at each side of the matelines.

Color to be: ( )

Floor Covering Type 2:

517 SF .080 commercial grade vinyl rolled goods at restrooms and janitor closet

Color to be: ( ).

#### Additional Floor Items Included in Quoted Price:

36"x36" Bilco floor hatch (T4) Bilco T-4 (36x36) type metal floor hatch with 1/8 in. carpet molding at Janitor's Closet 115. The locked floor hatch cannot be opended from the

top or bottom. Rough opening to be 3'-6 7/8" x 3'-6 7/8" at janitor closet

#### **EXTERIOR WALL CONSTRUCTION:**

2X6 #2 SYP equal or better at 16 in. O.C. w/ double 2X6 #2 SYP equal or better top plate Framing:

and single 2X6 #2 SYP or better bottom plate. (3-2x6 header with (2) 1/2 in. shim at all

exterior openings unless otherwise noted)

Wall Sheathing: 7/16" OSB

Insulation: R-21 Kraft back fiberglass batt

Siding Type: 26 GA PBR-Panel steel siding with house wrap underlayment. Siding body color: ( )

Corner trim color: ( ) Door & window trim color: ( ) Bottom horizontal trim color: ( ) Top horizontal trim color: (

Covering height: 8 ft.

Wall Covering 1: 5/8 in. vinyl covered gypsum w/wrapped battens. Color to be: (HAMPTON GRAY, RUFF STUFF WHITE, OR RUFF STUFF FROST)

Covering height: 10 ft.

Wall Covering 2: Standard White FRP panels over 5/8 in. MR Board at Restrooms & Janitors closet

Covering height: 4 ft.

## **INTERIOR WALL CONSTRUCTION:**

2X4 #2 SYP equal or better at 16 in. o.c. w/double 2X4 #2 SYP equal or Framing:

better top plates and single 2X4 #2 SYP or better bottom plate

Overall height: FULL HEIGHT (Except plumbing and plenum walls at 8'-0") R-11 unfaced battens for sound attenuation at all walls

Standard White FRP panels over 5/8 in. MR Board at Restrooms & Utility closet

Wall Covering 1: 5/8 in. vinyl covered gypsum w/wrapped battens.

Color to be: (HAMPTON GRAY, RUFF STUFF WHITE, OR RUFF STUFF FROST)

Covering height: 8 ft.

Covering height: 4 ft.

Base Trim: 4 in. vinyl cove. Color to be: ( )

Interior window trim color to be: (GRAY, FROST OR WHITE) Window Trim:

Hold Back Gyp: Hold back gypsum at matelines to first stud (YES or NO)

#### Additional Interior Wall Items Included in Quoted Price:

Interior shearwall to extend to rafters with 3/8 in. CDX plywood on one side of the

wall. See floor plan for location of interior shearwall.

One hour fire rated walls are extended to the bottom of rafters (see floor plan for locations).

#### **ROOF CONSTRUCTION:**

Roof Type: Transverse ridge

2X10 #2 SYP equal or better (Roof diaphragm chord tie (HTT4) at top plates of endwalls Rafter size:

on the interior side of building supplied by IBI and shipped loose to be installed on-site at

each mateline)

16 in. O.C. Spacing: Multi-layer laminated plywood (Group 1, 5 ply) Mate Beam:

20 in. to 27 1/2 in. to 20 in. Height:

Length: No. of Layers:

No. of Beams:

8980 SF 2 ft. x 4 ft. Standard T-Grid at 7'-10" (Mineral Fiber Tile #769) Ceiling:

installed at factory, held back at matelines. Completion of ceiling installation

on-site by others; not in Indicom's scope.

R-38HD unfaced fiberglass batt with support netting Insulation: 7/16 in. OSB with Mulehide "FR" adhesive (Class C) Sheathing:

45 mil white on black EPDM 3 year aged Solar reflectance index 77 Roofing:

Additional Roof Items Included in Quoted Price:

Add rafters or blocking with 5/8 in. Type-X gypsum above all fire rated walls to extend fire

rating to roof deck. (See detail).

#### **EXTERIOR/INTERIOR DOORS:** (SEE DOOR SCHEDULE)

**WINDOWS:** (SEE WINDOW SCHEDULE)

**CABINETS:** (SEE CABINET SCHEDULE)

MANUFACTURER: BURLESON, TX. 76028 DESIGN CRITERIA / LOADS: NO OF MODULES. BUILDING SQ.FT TYPE OF CONSTRUCTION OCCUPANCY USE GROUP OCCUPANCY LOAD. FLOOR LIVE LOAD. 50 psf. (2000 lb concentrate (100 psf. at Corridor) (150 psf. at Library) ROOF LIVE LOAD. ROOF DEAD LOAD. SOLAR PANEL ALLOWANCE WIND LOAD. OCCUPANCY/RISK CATG. SEISMIC DESIGN CATEGORY. SEISMIC. S1 PERMISSIBLE GAS TYPE. AME AND DATE OF CODES; AND 2022 TAS **SPECIAL CONDITIONS AND OR** LIMITATIONS: THE OWNER SHALL BE RESPONSIBLE TO INSTALL AN PPROVED AND LISTED COMPONENT IN ACCORDANCE VITH ASTM E 1996 OR ASTM E 1866 FOR THE PROTECT OF ALL EXTERIOR OPENINGS (WINDOWS, DOORS AND BORNE DÉBRIS REGION IN ACCORDANCE WITH THE ITERNATIONAL BUILDING CODE SECTION 1609.1.2. PRIC MANUFACTURER'S OBLIGATIONS ARE CONTAINED IN THE TERMS OF ITS ONE YEAR MANUFACTURED BUILDING NOT INCLUDED IN SCOPE OF WORK PORCHES, STEPS, AND RAMPS TO BE SUPPLIED AND INSTALLED BY OTHERS IN ACCORDANCE WITH THE IBO THESE DRAWINGS PORTABLE FIRE EXTINGUISHERS TO BE SUPPLIED AN REMAIN THE PROPERT INSTALLED ON SITE BY OWNER IN ACCORDANCE WITH OF INDICOM BUILDINGS SERVICE SINK PROVIDED IN ADJACENT BUILDING OF NC. AND ARE NOT TO E THE SAME PROPERTY . ANY REQUIRED SPRINKLER / FIRE ALARM / USED IN ANYWAY FIRE/SMOKE DETECTION AND/OR SUPPRESSION AS WITHOUT WRITTEN REQUIRED BY THE IBC/IFC AND OR LOCAL FIRE AUTHORITY TO BE INSTALLED BY OTHERS ON-SITE IN PERMISSION. ACCORDANCE WITH THE LOCAL BUILDING THE BUILDING OWNER IS RESPONSIBLE FOR THE DEALER: DEVELOPMENT & DESIGN OF ALL SITE REQUIRED ACCESSIBILITY ELEMENTS, THESE ELEMENTS ARE PACIFIC MOBILE NOT INCLUDED IN THE SCOPE OF THIS DESIGN STRUCTURES SUBMITTALS ARE REQUIRED BY OWNER THROUGH THEIR DESIGN PROFESSIONAL . INSTALLATION AND COMPLETE WATERTIGHT WEATHER SEALING IS THE RESPONSIBILITY OF THE PURCHASER, SPECIAL CONSIDERATION SHOULD BE PROJECT: GIVEN TO LOCAL, COASTAL OR EXTREME WEATHER DO-1130-2024 PMS WESTHOFF, TX CLASSROOM **IDENTIFICATION:** NOTE: DATA PLATE, NTA LABEL AND ALL STATE DECALS PROJECT: DO-1130 (EXCEPT TX) TO BE LOCATED ON PANEL BOX DOOR OR HALL BE PLACED ON THE INTERIOR SIDE OF THE EXTERIOR WALL @ THE HITCH END ABOVE THE T-GRID STATES: LOCATION. TDLR DECAL TO BE LOCATED ON THE HITCH SERIAL NUMBERS: SITE PLAN NOT AVAILABLE AT THIS TIME. BUILDING GREATER THAN 10 FT. IN ACCORDANCE WITH THE IBO THIS PLAN MAY BE REVERSED AND/OR MIRRORED DRAWN BY: . SEE STRUCTURAL PACKAGE FOR ALL STRUCTURAL STANDARDS AND DETAILS . BUILDING WILL NOT BE LOCATED IN A FLOOD HAZARD 5. BUILDING SHALL NOT BE SITED WHERE LOCAL PLOT DATE: CONDITIONS EXCEED THE DESIGN PARAMETERS FIRE RATED DOORS AND ASSEMBLIES SHALL COMPL 9/17/2025 WITH SECTION 715 OF THE IBC INTERIOR WALL PARTITIONS COMPLY WITH SEC 16 OF THE 2021 IBC CODE REV # / DATE: 3. INTERIOR WALL PARTITIONS COMPLY WITH SEC 1607 OF THE 2018 IBC CODE. ). INTERIOR WALL PARTITIONS COMPLY WITH SEC 1607. OF THE 2015 IBC CODE THE BUILDING OWNER IS RESPONSIBLE FOR THE DEVELOPMENT & DESIGN OF ALL SITE REQUIRED ACCESSIBILITY FLEMENTS. THESE FLEMENTS ARE NOT INCLUDED IN THE SCOPE OF THIS DESIGN. SUBMITTALS ARE REQUIRED BY OWNER THROUGH THEIR DESIGN PROFESSIONAL IN ACCORDANCE WIT THE TEXAS ARCHITECTURAL BARRIERS ACT TO: TEXAS DEP. OF LICENSING AND REGULATIONS ARCHITECTURAL BARRIERS SECTION P.O. BOX 12157 - AUSTIN, TX 78711 . DOOR CLOSERS SHALL COMPLY WITH THE REQUIREMENTS IN TAS 404.2.8.1 AND 404.2.8 FOR CLOSING SPEED AND OPENINGFORCE.

UNBELT

#### **IECC REQUIREMENTS** SWITCHING SCHEMES: PER ELECTRICAL PLAN LIGHTS MUST COMPLY WITH IECC COD

HVAC SEER RATING: HVAC EER RATING: 9.0 MINIMUM OF THE IECC CODE. MUST COMPLY WITH SECTION 403.2.9 DUCT INSULATION: OF THE IECC CODE. DUCT SEALING: MUST COMPLY WITH SECTION 403.2.9 OF THE IECC CODE. WATER HEATERS: MUST COMPLY WITH SECTION 404 OF THE IECC CODE.
MUST COMPLY WITH SECTION 405.3 OF EXIT SIGNS: THE IECC CODE. (ENERGY CONSUMPTION LESS THAN 5W PER SIDE)

OF THE IECC CODE.

\_\_ APPROVED APPROVED EXCEPT AS NOTED ☐ REVISE AND RESUBMIT

"PLEASE REVIEW DRAWINGS AND SPECIFICATIONS CAREFULLY. WHILE EVERY EFFORT IS MADE TO ASSURE THE DRAWINGS REFLECT THE EXPECTATIONS AND QUOTATION, THE FINAL CONSTRUCTION WILL BE BASED SOLELY ON THE

SPECIFICATIONS AND DRAWINGS APPROVED.


PHOENIX, AZ. 85043 (602) 447-6460 SHEET:

SHAYLON VAUGHN, P.I

CORPORATE ENGINEE

SUNBELT MODULAR

5301 W. MADISON ST.

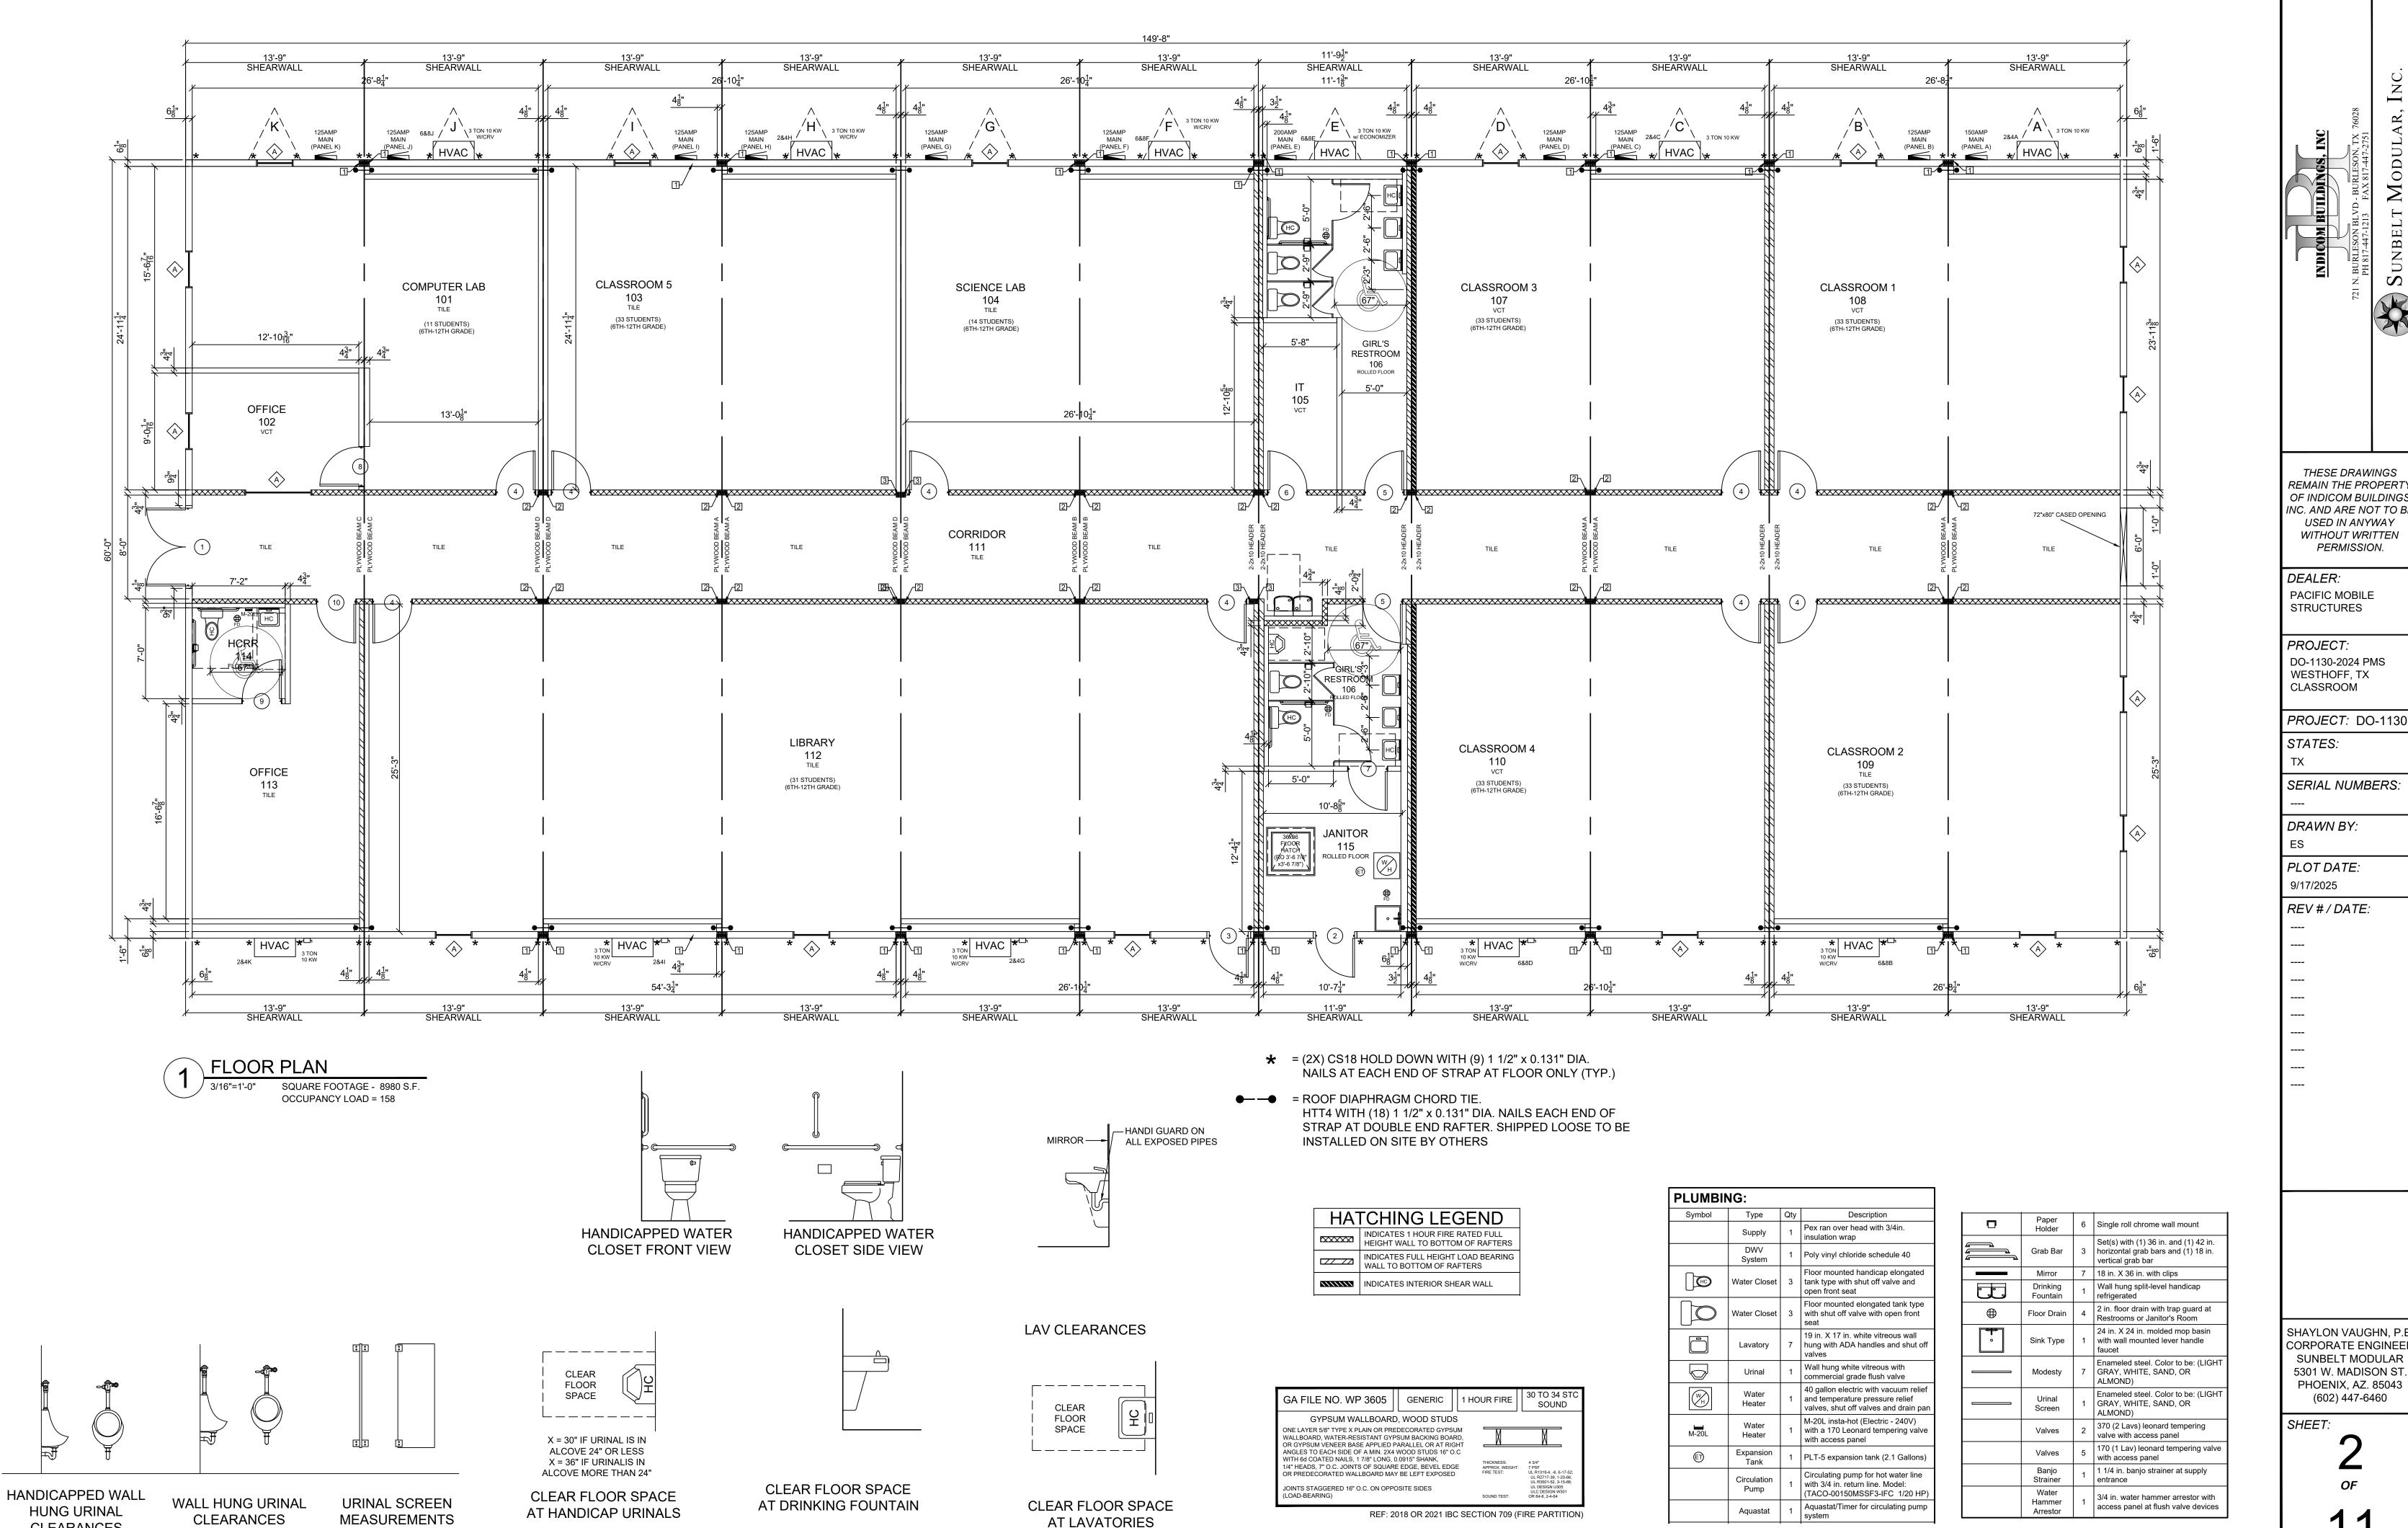

**CLEARANCES** 

THESE DRAWINGS REMAIN THE PROPERTY

Modul

DEALER: PACIFIC MOBILE STRUCTURES

USED IN ANYWAY

WITHOUT WRITTEN PERMISSION.

PROJECT: DO-1130-2024 PMS WESTHOFF, TX CLASSROOM

STATES:

DRAWN BY:

PLOT DATE:

REV # / DATE:

SHAYLON VAUGHN, P.E **CORPORATE ENGINEER** SUNBELT MODULAR

(602) 447-6460 SHEET:


5301 W. MADISON ST.

PHOENIX, AZ. 85043

WI	ND	OWS:							
Qty	NO.	Туре	Glazing	Size	Rough Opening	U-Factor	SHGC	Mini-Blind	Notes
16	А	VINYL VERTICAL SLIDER WITH 28 IN. SASH. (KINRO 9750). W/ARGON COLOR TO BE: ()	CLEAR, DUAL GLAZED, LOW-E	32"x60"	31 3/4"x59 3/4"	.34	.23	THIN LINE METAL MINI-BLINDS. COLOR TO BE: (GRAY, WHITE SATIN OR ALABASTER)	TOP OF WINDOW AT 6'-8" AFF
1	В	REDI-FRAME FIXED WINDOW WITH BROWNTONE COLORED METAL FRAME	FIRE RATED GLASS	60"x60"	59 3/4"x59 3/4"	N/A	N/A	NONE	TOP OF WINDOW AT 6'-8" AFF

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Qty	NO.	Туре	Jamb	Glazing	Wall Thickness	Size	Rough Opening	U-Factor	Color	Closer	Deadbolt	Hardware	Fire Rating	Keying	Notes
1	1	COMMERCIAL DBL. STEEL, INSULATED 18 GA.	16 GA.	10X10 TEMPERED WINDOW (OBSCURED GLASS BY OTHERS)	6 1/8"	72 x 80	76 1/2"x82 1/2"	.14	COLOR TO BE: ()	HYDRAULIC CLOSER, TELL BRAND 900 SERIES	NONE	PANIC HARDWARE WITH KEYED LEVER, TELL BRAND 8300 SERIES	NONE	ALIKE OR SEPARATE	WITH REMOVABLE MULLION
1	10	PREFINISHED GOLDEN OAK SOLID CORE	WITH BROWNTONE METAL JAMB	6X27 PENCIL WINDOW WITH FIRE GLASS AND TEMPERED (BOTTOM OF GLAZING REQUIRED TO BE 43" AFF)	4 3/4"	36 x 80	37 1/4"x81"	N/A	NONE	HYDRAULIC CLOSER (12641)	NONE	OFFICE FUNCTION, REMOVABLE CORE, TELL BRAND, GRADE 2 (LC2482CTL)	20 MINUTE LABEL	ALIKE	SMOKE SEALS, DOOR SWEEPS AND FLOOR MOUNT STOPS
1	2	COMMERCIAL STEEL, INSULATED 18 GA.	16 GA.	NONE	6 1/8"	36 x 80	40 1/2"x82 1/2"	.14	COLOR TO BE: ()	HYDRAULIC CLOSER (TELL BRAND 900 SERIES)	STANDARD DEADBOLT, TELL BRAND, GRADE 2, DB2051	STOREROOM FUNCTION, TELL BRAND, GRADE 2 (LC2486CTL)	NONE	ALIKE OR SEPARATE	N/A
1	3	COMMERCIAL STEEL, INSULATED 18 GA.	16 GA.	10X10 TEMPERED WINDOW (OBSCURED GLASS BY OTHERS)	6 1/8"	36 x 80	40 1/2"x82 1/2"	.14	COLOR TO BE: ()	HYDRAULIC CLOSER (TELL BRAND 900 SERIES)	NONE	PANIC HARDWARE WITH KEYED LEVER, TELL BRAND 8300 SERIES	NONE	ALIKE OR SEPARATE	N/A
9	4	PREFINISHED GOLDEN OAK SOLID CORE	WITH BROWNTONE METAL JAMB	6X27 PENCIL WINDOW WITH FIRE GLASS AND TEMPERED (BOTTOM OF GLAZING REQUIRED TO BE 43" AFF)	4 3/4"	36 x 80	37 1/4"x81"	N/A	NONE	HYDRAULIC CLOSER (12641)	NONE	CLASSROOM FUNCTION LEVER, TELL BRAND, GRADE 2 (LC2484CTL)	20 MINUTE LABEL	ALIKE	SMOKE SEALS, DOOR SWEEPS AND FLOOR MOUNT STOPS
2	5	PREFINISHED GOLDEN OAK SOLID CORE	WITH BROWNTONE METAL JAMB	NONE	4 3/4"	36 x 80	37 1/4"x81"	N/A	NONE	HYDRAULIC CLOSER (12641)	NONE	PASSAGE LEVER, TELL BRAND, GRADE 2 (LC2475CTL)	20 MINUTE LABEL	NONE	SMOKE SEALS, DOOR SWEEPS AND FLOOR MOUNT STOPS
1	6	PREFINISHED GOLDEN OAK SOLID CORE	WITH BROWNTONE METAL JAMB	NONE	4 3/4"	36 x 80	37 1/4"x81"	N/A	NONE	HYDRAULIC CLOSER (12641)	NONE	STOREROOM FUNCTION, REMOVABLE CORE, TELL BRAND, GRADE 2 (LC2486CTL)	20 MINUTE LABEL	ALIKE	SMOKE SEALS, DOOR SWEEPS AND FLOOR MOUNT STOPS
1	7	PREFINISHED GOLDEN OAK SOLID CORE	WITH BROWNTONE METAL JAMB	NONE	4 3/4"	36 x 80	37 1/4"x81"	N/A	NONE	HYDRAULIC CLOSER (12641)	NONE	STOREROOM FUNCTION, REMOVABLE CORE, TELL BRAND, GRADE 2 (LC2486CTL)	NONE	ALIKE	FLOOR MOUNT STOPS
1	8	PREFINISHED GOLDEN OAK SOLID CORE	WITH BROWNTONE METAL JAMB	NONE	4 3/4"	36 x 80	37 1/4"x81"	N/A	NONE	HYDRAULIC CLOSER (12641)	NONE	OFFICE FUNCTION, REMOVABLE CORE, TELL BRAND, GRADE 2 (LC2482CTL)	NONE	ALIKE	FLOOR MOUNT STOPS
1	9	PREFINISHED GOLDEN OAK SOLID CORE	WITH BROWNTONE METAL JAMB	NONE	4 3/4"	36 x 80	37 1/4"x81"	N/A	NONE	HYDRAULIC CLOSER (12641)	NONE	PRIVACY LEVER, TELL BRAND, GRADE 2 (LC2476CTL)	NONE	ALIKE	FLOOR MOUNT STOPS

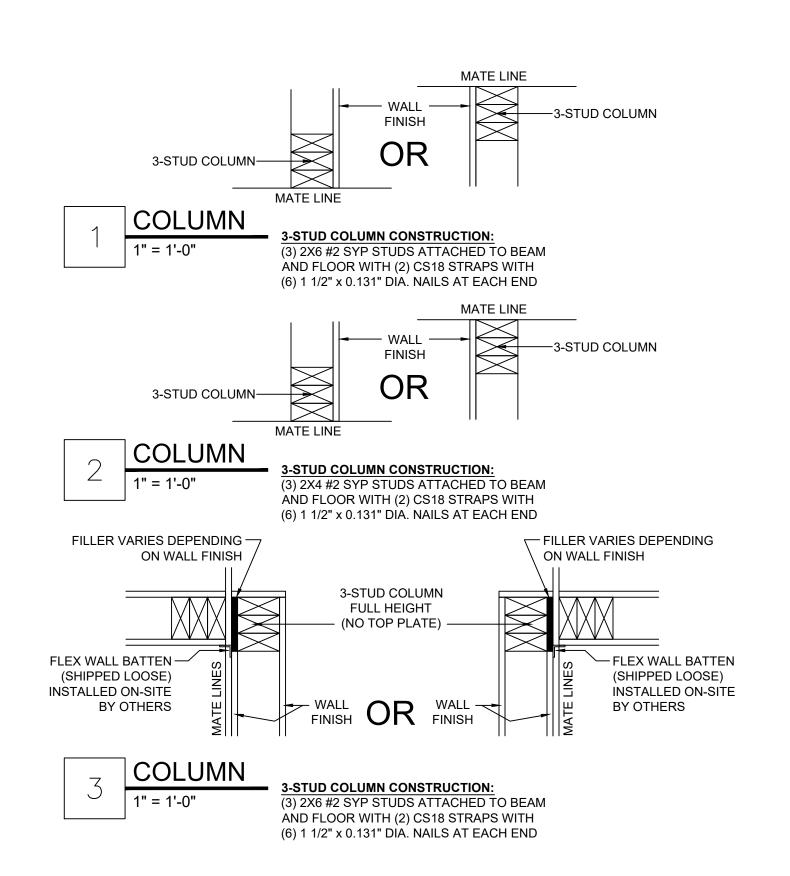

		FASTE	NING SCHEDULE
		TYPE	FASTENING
	FLOOR DECKING	3/4" T&G STURD-I- FLOOR PLYWOOD	(2" 16 GAGE STAPLES, 7/16 CROWN AND GLUE ADHESIVE) @ 4" O.C. AT PANEL EDGE AND 8" O.C. AT INTERMEDIATE SUPPORTS
	SIDEWALLS	7/16" OSB	(2 3/8"x0.113" DIA. NAIL) @ 6" O.C. AT STUDS AND 12" O.C. AT INTERMEDIATE STUDS
LOCATIONS	ENDWALLS (SHEARWALLS)	7/16" OSB	(2 3/8"x0.113" DIA. NAIL) @ 6" O.C. AT STUDS AND 12" O.C. AT INTERMEDIATE STUDS
	INTERIOR (SHEARWALLS)	NONE	NONE
	ROOF DECKING		#N/A
	SIDING (SIDEWALLS)	26 GA R-PANEL SIDING (113 - 125 MPH WIND)	(#14 WOODTITE SCREWS) (40" O.C. HORIZONTAL ROW SPAING) AT 12" O.C. SPACING EACH ROW
	SIDING (ENDWALLS)	26 GA R-PANEL SIDING (113 - 125 MPH WIND)	(#14 WOODTITE SCREWS) (40" O.C. HORIZONTAL ROW SPAING) AT 12" O.C. SPACING EACH ROW

T21 N. BURLESON BLVD - BURLESON, TX 76028
PH 817-447-1213 FAX 817-447-2751

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PERMISSION.

DEALER:
PACIFIC MOBILE
STRUCTURES

PROJECT:
DO-1130-2024 PMS
WESTHOFF, TX
CLASSROOM

PROJECT: DO-1130 STATES:

TX
SERIAL NUMBERS:

DRAWN BY:

ES

PLOT DATE:

9/17/2025

REV # / DATE:

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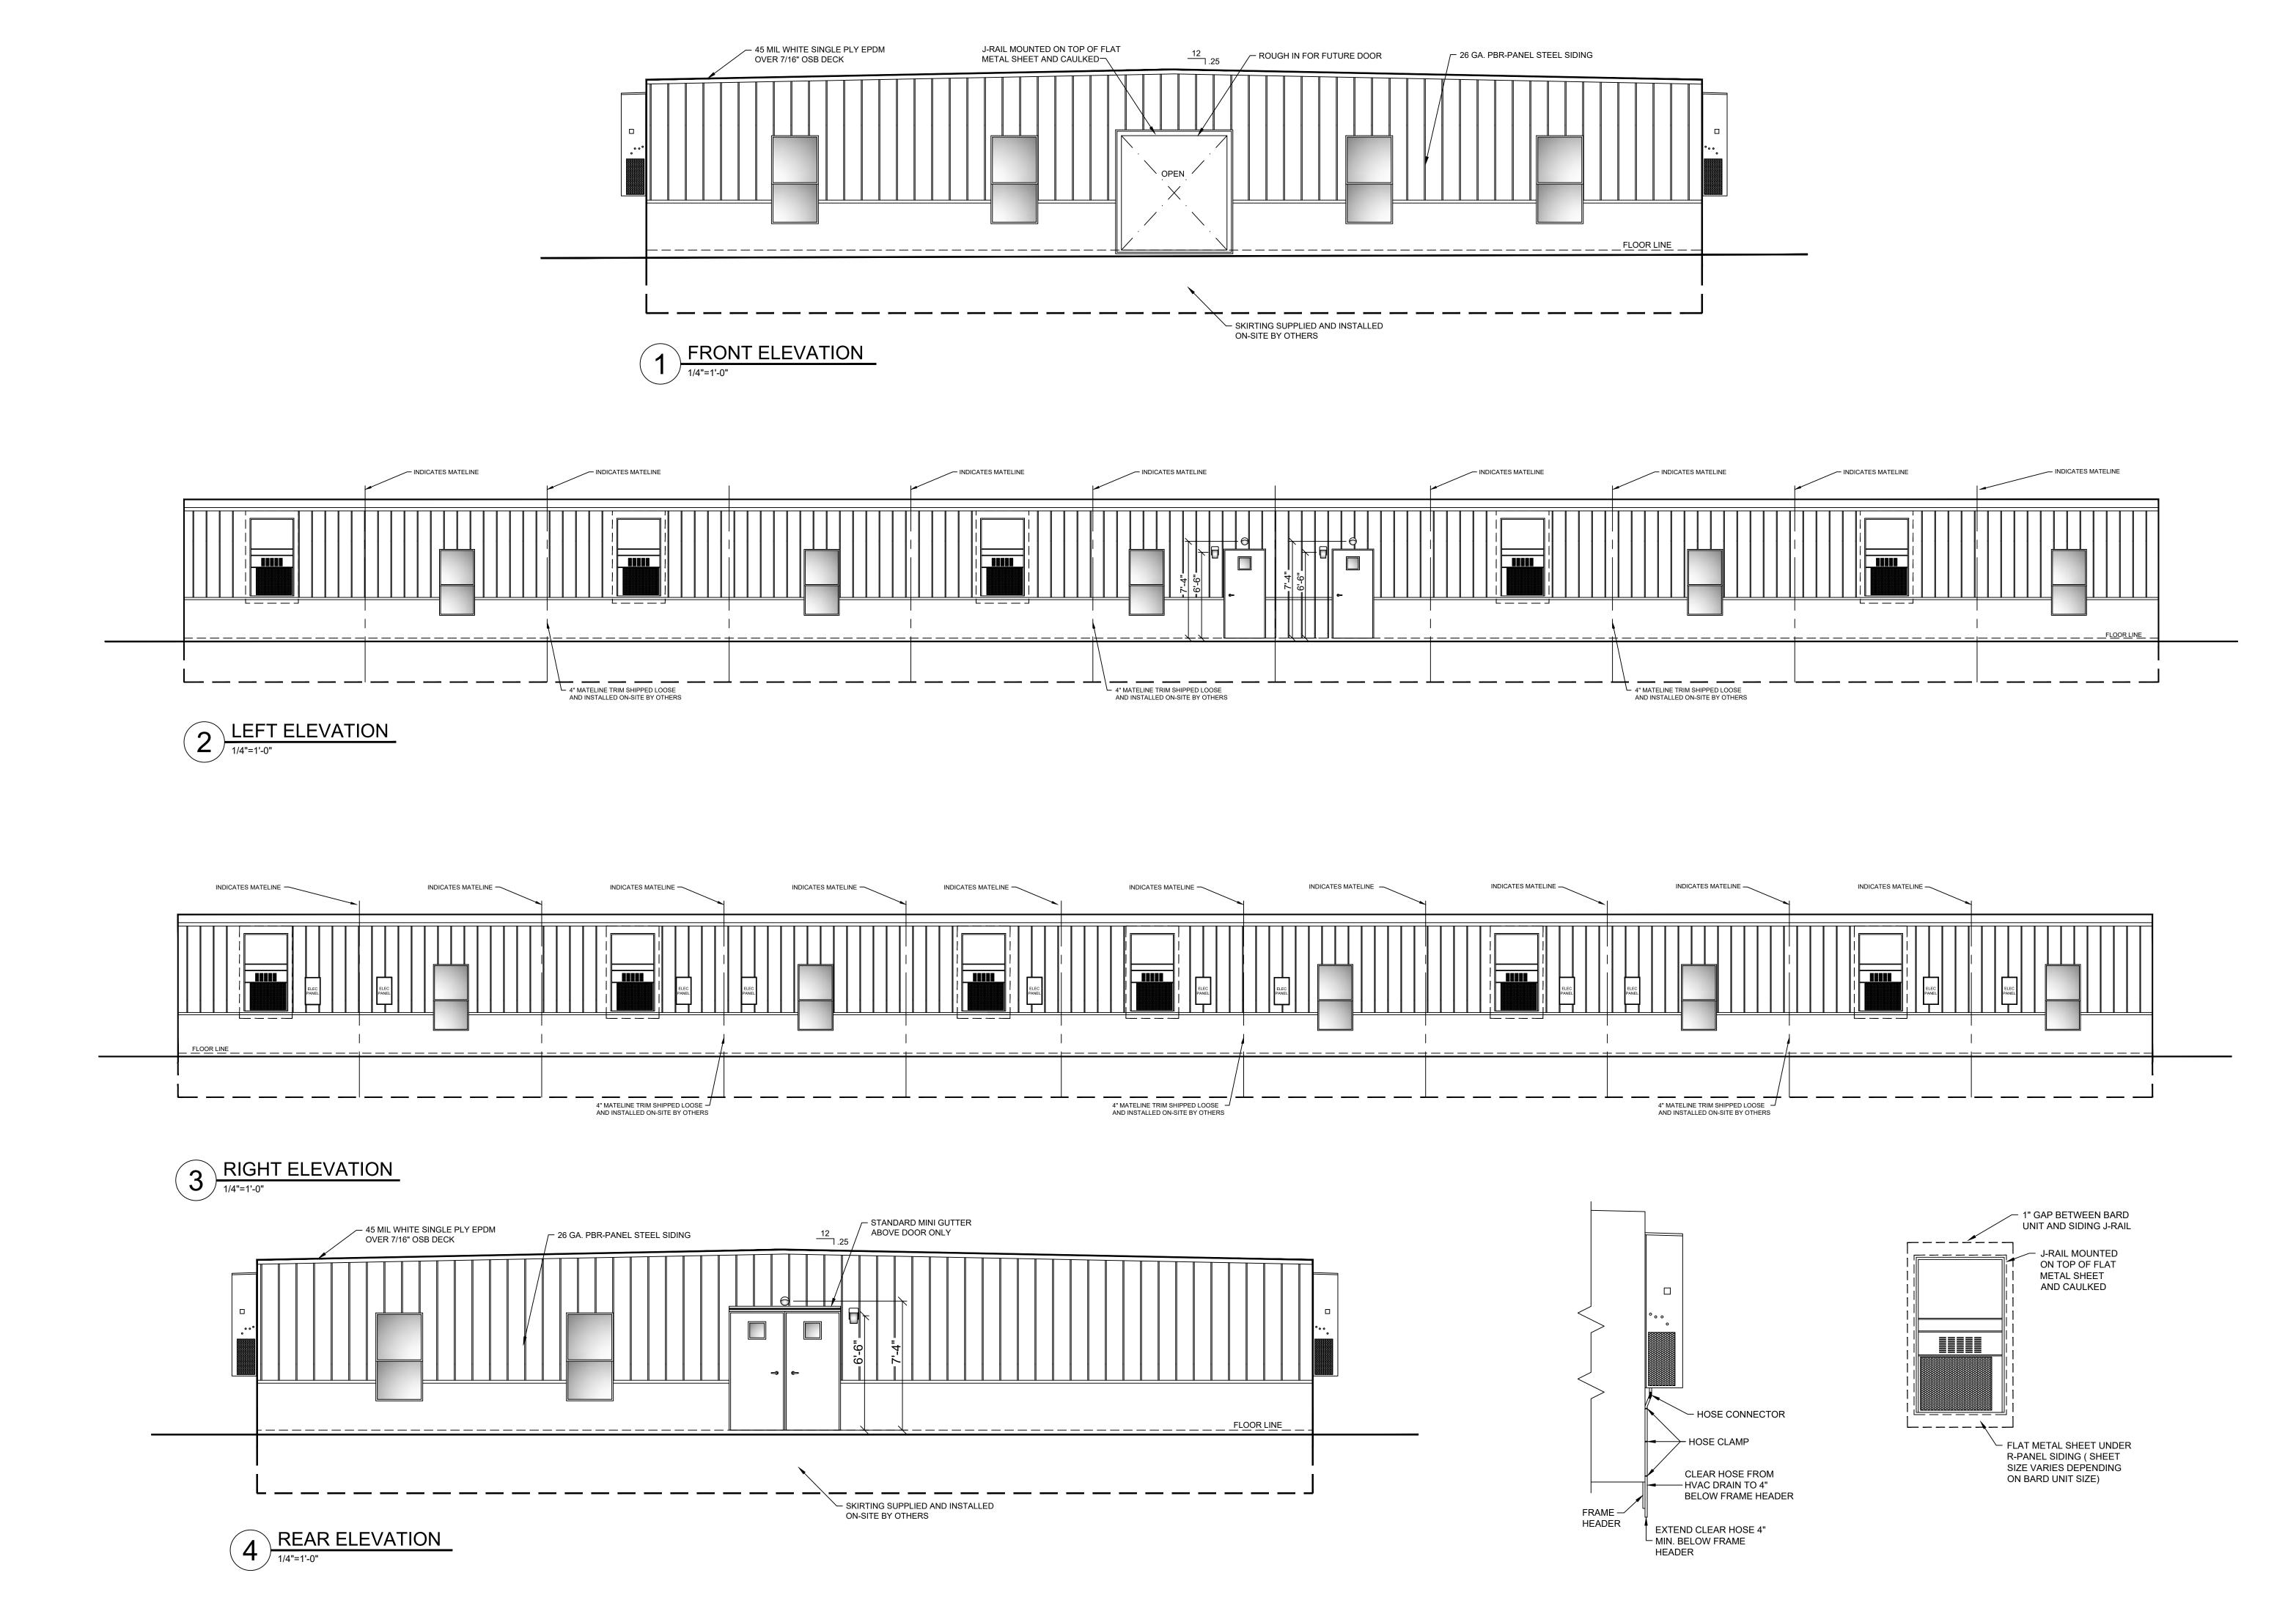
SHAYLON VAUGHN, P.E CORPORATE ENGINEER SUNBELT MODULAR 5301 W. MADISON ST.

SHEET:

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PHOENIX, AZ. 85043

(602) 447-6460



INDICOM BUILDINGS
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PROJECT:
DO-1130-2024 PMS
WESTHOFF, TX
CLASSROOM

PROJECT: DO-1130

STATES:

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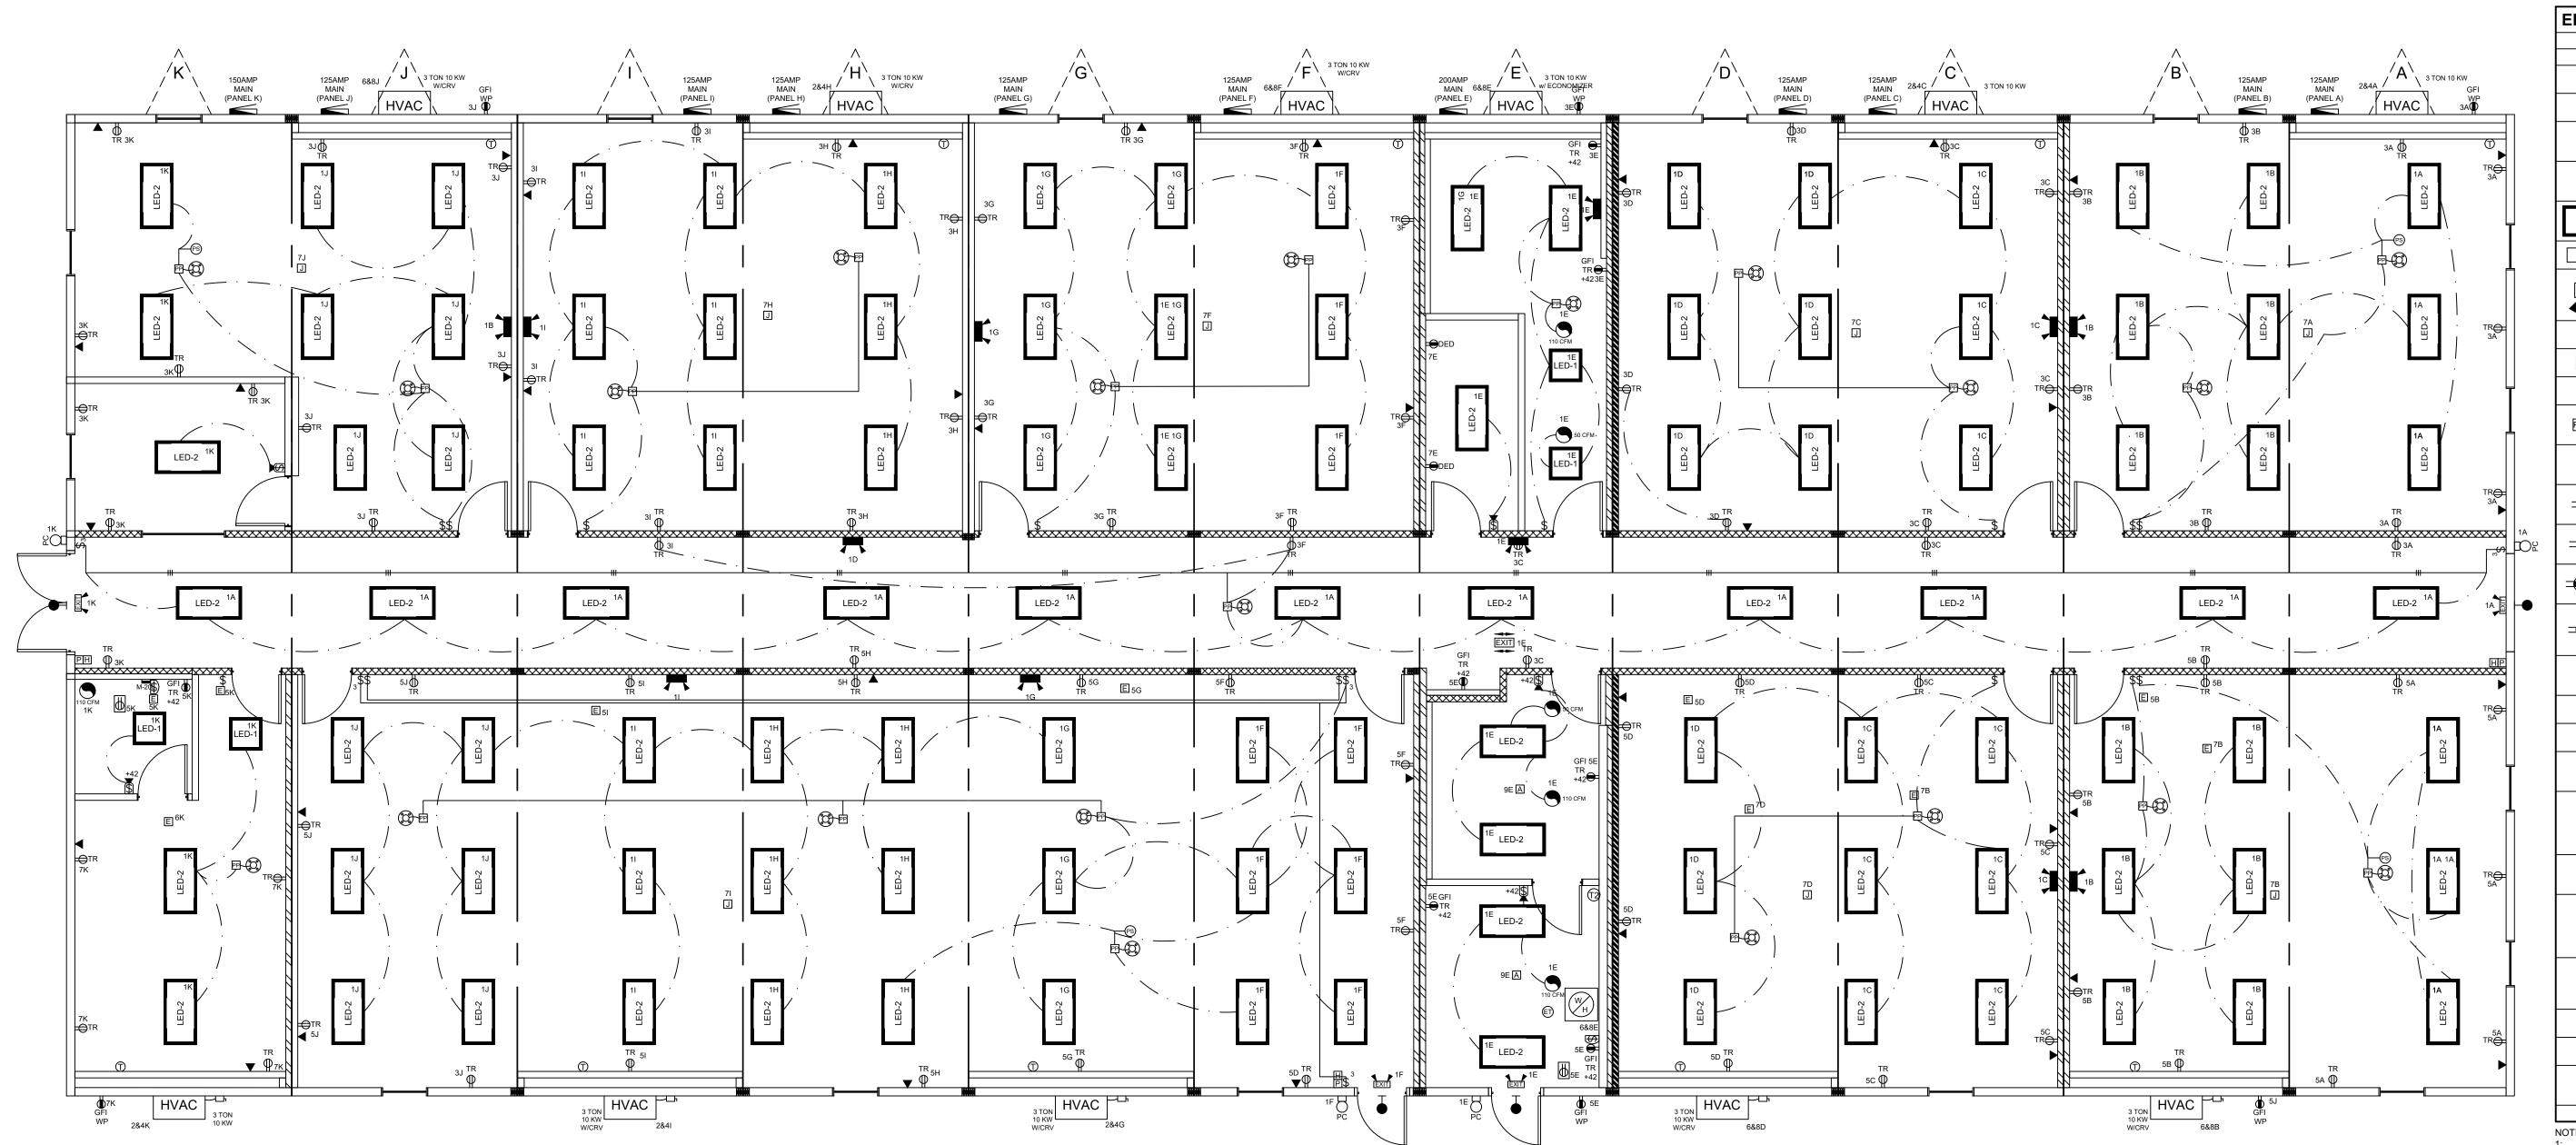
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SHAYLON VAUGHN, P.E. CORPORATE ENGINEER SUNBELT MODULAR 5301 W. MADISON ST. PHOENIX, AZ. 85043 (602) 447-6460

SHEET:

**4** *OF* 



1 ELECTRICAL PLAN
3/16"=1'-0"

				INDIA T21 N. BURLE PH 817-
ELECTR	ICAL:			721 7
Symbol	Туре	Qty	Description	
	Elec Service	1	120/240V. 60 HZ. single phase	
	Elec Panel	1	1 PH 200 amp w/200 main breaker with clips. Exterior mount NEMA 3R 1 PH 125amp w/125 main breaker	
	Elec Panel	10	with clips. Exterior mount NEMA 3R  E.M.T. thin wall conduit with	
	Elec Raceway	1	separate green ground and neutrals with wire insulation to be THHN	
LED-1	Light	4	2' x 2' flat panel LED (4000 lumens) recessed lay-in with dimmable electronic ballast (40 watts)	
LED-2	Light	116	2' x 4' flat panel LED (5000 lumens) recessed lay-in with dimmable electronic ballast (40 watts)	THESE DRAWINGS
PC	Light	4	7.5 watt LED exterior with photocell mounted 78 in. to center of box	THESE DRAWINGS REMAIN THE PROPERT
EXIT	Emerg. Light	4	Combo dual emergency light/exit sign (Green lens) with battery backup and remote mounted 88 in. A.F.F.	OF INDICOM BUILDING INC. AND ARE NOT TO E USED IN ANYWAY WITHOUT WRITTEN
	Emerg. Light	12	Interior double head battery pack mounted 88 in. A.F.F.	PERMISSION.
$\vdash$	Emerg. Light	4	Exterior remote head mounted above exterior door at 88 in. A.F.F.	DEALER:
EXIT	Exit Sign	1	115v with battery backup mounted 88 in. A.F.F. or in T-grid	PACIFIC MOBILE
	Occupancy Sensor	20	Ceiling mounted occupancy sensor (Legrand CI 305 W/ BZ 50 power pack)	STRUCTURES
PS	Photosensor	4	Ceiling mounted dimming photo- sensor. (WattStopper LightSaver LS-301)	PROJECT: DO-1130-2024 PMS
⇒TR	Receptacle	88	20a/125v tamper resistant duplex with cover plate mounted 15 in. A.F.F.	WESTHOFF, TX CLASSROOM
⊕GFI TR	Receptacle	7	20a/125v GFCl protected tamper resistant receptacle with cover plate mounted 42 in. A.F.F.	PROJECT: DO-1130
DED GFI	Receptacle	2	20a/125v dedicated GFCI receptacle with cover plate on breaker mounted 15 in. A.F.F.	STATES:
⇒ GFI WP	Receptacle	6	20a/125v GFCI 'WR' rated exterior receptacle with weatherproof in-use extra duty cover mounted 15 in. A.F.F.	SERIAL NUMBERS:
	Receptacle	2	20a/125v GFCI protected 'WR' rated heat tape receptacle below unit with weatherproof cover	DRAWN BY:
	Data Box	37	Empty 2x4 J-box stubbed above ceiling with 3/4 in. EMT conduit	ES
Α	J-Box	2	Powered 4x4 J-box above T-grid for circulating pump. (Box with Letter A)	PLOT DATE:
E	J-Box	10	Powered 2x4 J-box above T-grid for fire/smoke damper. (Box with Letter E)	9/17/2025
Н	J-Box	3	Empty 4x4 J-box with blank cover at 80 in. AFF to bottom with single gang mud ring and 1 in. conduit stubbed up for horn strobe by alarm provider. (Box with letter H)	REV # / DATE: 
J	J-Box	8	Powered 4x4 J-box with blank cover above T-grid for future use. (Box with letter J)	
Р	J-Box	3	Empty 4x4 J-box with blank cover at 46 in. AFF to bottom with single gang mud ring and 1 in. conduit stubbed up for pull station by alarm provider. (Box with letter P)	
\$	Switch	5	Wall vacancy sensor switch at door (Intermatic IOS-DOV) (Indicom factory set to manual on - auto off) See plan for mounted height	
\$	Switch	14	Standard toggle switch with cover plate mounted 46 in. A.F.F.	
\$3	Switch	5	3-way toggle switch with cover plate mounted 46 in. A.F.F.	
\$	Switch	2	Disconnect switch with (RED) cover plate mounted 46 in. A.F.F. for water heater	
	Device Color	1	Color to be: (WHITE OR BEIGE)	l <b> </b>


ALL AFF DIMENSIONS ARE TO THE BOTTOM OF THE DEVICE BO.
 UNLESS NOTED "TO CENTER"


 BLANK COVERS SHALL BE ADDED TO ANY J-BOX THAT IS FOR FUTURE USE

SHAYLON VAUGHN, P.E. CORPORATE ENGINEER SUNBELT MODULAR 5301 W. MADISON ST. PHOENIX, AZ. 85043 (602) 447-6460

SHEET:

**5** 

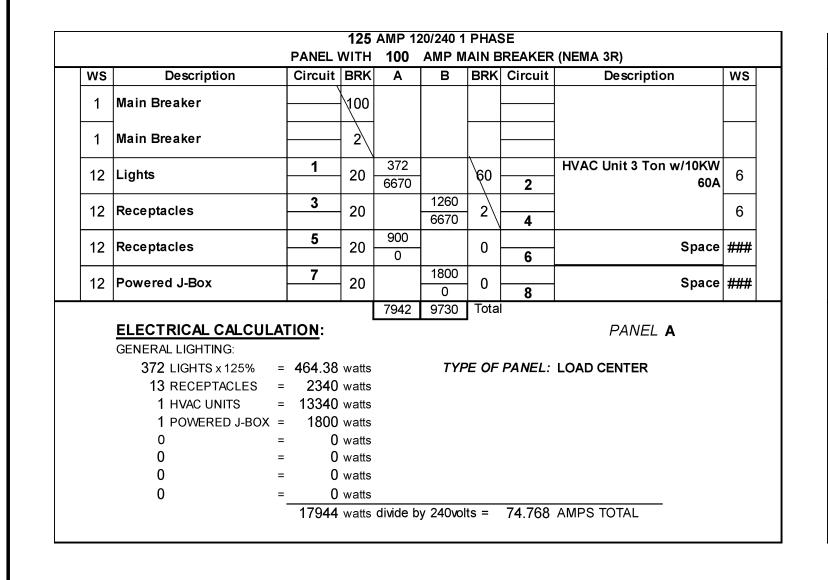

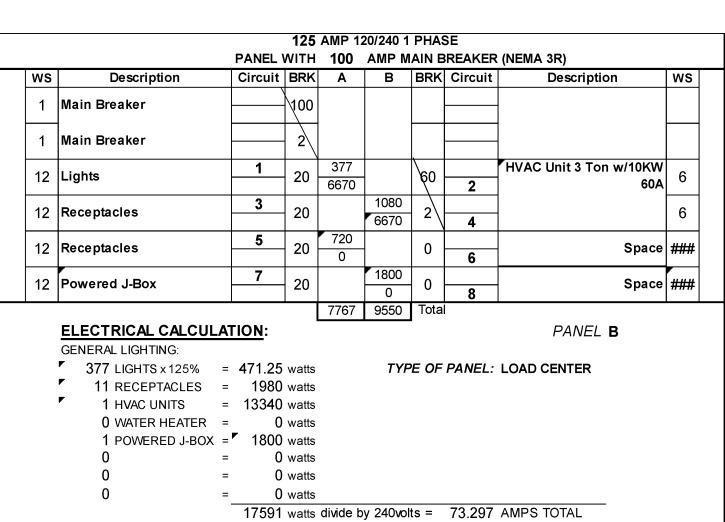

		PANEL '	WITH	100	AMP M	AIN E	REAKER	(NEMA 3R)	
ws	Description	Circuit	BRK	Α	В	BRK	Circuit	Description	ws
1	Main Breaker		100						
1	Main Breaker		2						
12	Lights	1	20	394 6670		60	2	HVAC Unit 3 Ton w/10KW 60A	6
12	Receptacles	3	20		900 6670	2	4		6
12	Receptacles	5	20	720 0		0	6	Space	###
12	Powered J-Box	7	20		1800	0	8	Space	###
	ELECTRICAL CALCULA GENERAL LIGHTING:	ATION:		7784	9370	Tota		PANEL <b>C</b>	
	10 RECEPTACLES 1 HVAC UNITS 1 POWERED J-BOX		watts watts		TYF	PE OF	PANEL:	LOAD CENTER	
		_	watts watts						
	•		watts						

					20/240 1				
		PANEL	WITH	100	AMP M	AIN B	REAKER	(NEMA 3R)	
ws	Description	Circuit	BRK	Α	В	BRK	Circuit	Description	ws
1	Main Breaker		100						
1	Main Breaker		2						
40	11.1.6	1		360		\		HVAC Unit 3 Ton w/10KW	
12	Lights		20	6670		60	2	60A	6
12		3	20		720	2			6
12	Receptacies		20		6670	\	4		0
12	Receptacles	5	20	720		0		Space	 
	. Сооршого			0			6	Орио	
12	Powered J-Box	7	20		1800	o		Space	###
					0		8	•	
	ELECTRICAL CALCULA	TION.		7750	9190	Total		DANELB	
	ELECTRICAL CALCULA	IION:						PANEL <b>D</b>	
	GENERAL LIGHTING:	450			T\/5	SE 05	DANE!	LOAD OFWEED	
	360 LIGHTS x 125% =		watts		IYF	'E OF	PANEL:	LOAD CENTER	
	9 RECEPTACLES =		watts						
	1 HVAC UNITS =	13340	watts						


17210 watts divide by 240volts = 71.708 AMPS TOTAL

0 watts

0 watts

0 watts

0 watts

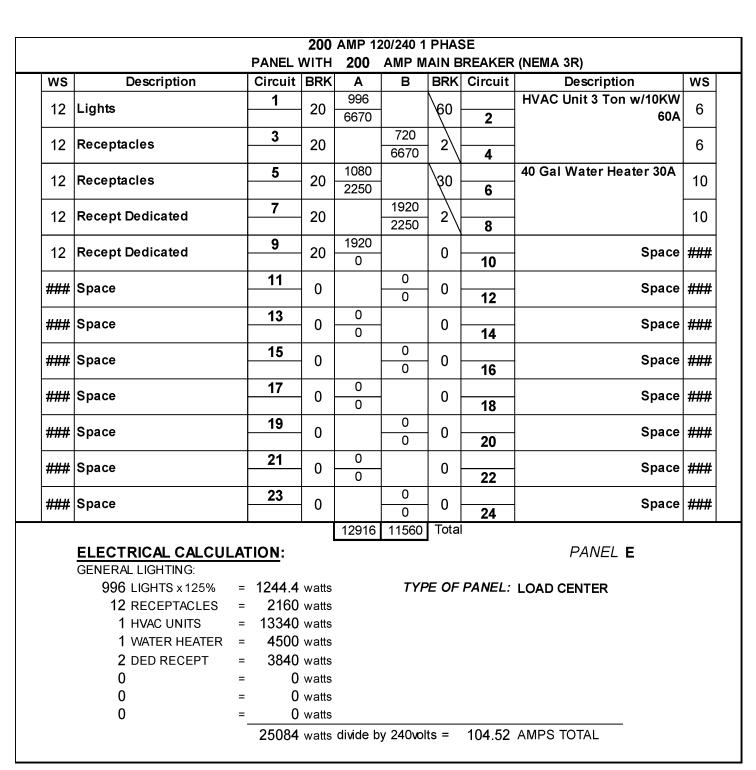

			125	AMP 1	20/240 1	PHAS	SE		
		PANEL	WITH	100	AMP M	AIN B	REAKER	(NEMA 3R)	
ws	Description	Circuit	BRK	Α	В	BRK	Circuit	Description	ws
1	Main Breaker		100						
1	Main Breaker		2						
12	Lights	1	20	349 6670	-	60	2	HVAC Unit 3 Ton w/10KW 60A	6
12	Receptacles	3	20		900 6670	2	4		6
12	Receptacles	5	20	1080 0		0	6	Space	###
12	Powered J-Box	7	20		1800 0	0	8	Space	###
		•	•	8099	9370	Total			
	ELECTRICAL CALCUL	ATION:	•					PANEL <b>F</b>	
	GENERAL LIGHTING:								
	349 LIGHTS x 125%	= 435.63	watts		TYF	PE OF	PANEL:	LOAD CENTER	
	12 RECEPTACLES	= 2160	watts						
	1 HVAC UNITS	= 13340	watts						
	1 POWERED J-BOX	= 1800	watts						
	0	= 0	watts						
	0	= 0	watts						
	0	= 0	watts						
	0	= 0	watts						

			PANEL '		100	20/240 1 AMP M			(NEMA 3R)	
NS	Description		Circuit	BRK	Α	В		Circuit	•	ws
1	Main Breaker	7	\	100						
1	Main Breaker	F		2						
12	Lights	-	1	20	394 6670		60	2	HVAC Unit 3 Ton w/10KW 60A	6
12	Receptacles		3	20		720 6670	2	4		6
12	Receptacles	-	5	20	360 0		0	6	Space	###
12	Space	1	7	0		0	0	8	Space	###
		•			7424	7390	Tota	ĺ		
	ELECTRICAL CALCUL	.AT	<u>ION</u> :						PANEL <b>G</b>	
	GENERAL LIGHTING:		400 =							
	394 LIGHTS x 125%					IYF	'E OF	PANEL:	LOAD CENTER	
	6 RECEPTACLES		13340	watts						
	1 HVAC UNITS 0	=		watts						
	0	=	_	watts						
	0	=	_	watts						
	0	=	_	watts						
	0	=		watts						

		PANEL '			20/240 1 AMP M			(NEMA 3R)	
ws	Description	Circuit	BRK	Α	В	BRK		Description	ws
1	Main Breaker		100						
1	Main Breaker		2						
12	Lights	1	20	497 6670		60	2	HVAC Unit 3 Ton w/10KW 60A	6
12	Receptacles	3	20		720 6670	2	4		6
12	Receptacles	5	20	540 0		0	6	Space	###
12	Powered J-Box	7	20		1800 0	0	8	Space	###
	ELECTRICAL CALCULA	ATION:		7707	9190	Total		PANEL <b>H</b>	
	8 RECEPTACLES 1 HVAC UNITS 1 POWERED J-BOX 0 0	= 0 = 0 = 0	watts watts		TYF	PE OF	PANEL:	LOAD CENTER	

					20/240 1			
		PANEL \	WITH	100	AMP M	IAIN E	REAKER	(NEMA 3R)
ws	Description	Circuit	BRK	Α	В	BRK	Circuit	Description
1	Main Breaker		100					
1	Main Breaker		2					
12	Lights	1	20	394 6670		60	2	HVAC Unit 3 Ton w/10KW 60A
12	Receptacles	3	20		900 6670	2	4	
12	Receptacles	5	20	360 0		0	6	
12	Powered J-Box	7	20		1800 0	0	8	Space
				7424	9370	Tota		
	ELECTRICAL CALCULA	<u>TION</u> :						PANEL I
	GENERAL LIGHTING:							
	<b>394</b> LIGHTS x 125%				TYF	PE OF	PANEL:	LOAD CENTER
	• NEGE: 1716226	= 1440						
		= 13340						
	1 POWERED J-BOX =							
	· ·	_	watts					
	•	_	watts					
	0 =	•	watts					
	0 =	- 0	watts					

ws	Description	Circ	uit BRK	Α	В	BRK	Circuit	Description	W
1	Main Breaker		100						
1	Main Breaker		2						
12	Lights	1	20	377 6670		60	2	HVAC Unit 3 Ton w/10KW 60A	6
12	Receptacles	3	20		1080 6670	2	4		6
12	Receptacles	5	20	720 0		0	6	Space	##
12	Powered J-Box	7	20		1800 0	0	8	Space	##
	ELECTRICAL CALCUL	ATION	<u> </u> :	7767	9550	Tota	•	PANEL <b>J</b>	
	377 LIGHTS x 125% 11 RECEPTACLES	= 19	.25 watts		TYF	PE OF	PANEL:	LOAD CENTER	
	1 HVAC UNITS 1 POWERED J-BOX 0 WATER HEATER	= 18	340 watts 300 watts 0 watts						
	0 0	= =	0 watts 0 watts						
	0	=	0 watts						

		PANEL						(NEMA 3R)	
ws	Description	Circuit	BKK		В	BRK	Circuit	Description	ws
12	Lights	1	20	986 6670	_	60	2	HVAC Unit 3 Ton w/10KW 60A	6
12	Receptacles	3	20		1080 6670	2	4		6
40	Receptacles	5	-00	360		75	-	M-20L Insta Water Heater	40
12			20	4800	1	25	6	20A	10
###	Space	7	0		900	0	8	Space	###
###	Space	9	0	0		0	10	Space	###
###	Space	11	0		0	0	12	Space	###
###	Space	13	0	0		0	14	Space	###
###	Space	15	0		0	0	16	Space	###
				12816	8650	Tota			•
ELECTRICAL CALCULATION:  GENERAL LIGHTING:  PANEL K									
986 LIGHTS x 125% = 1232.5 watts TYPE OF PANEL: LOAD CENTER									
	13 RECEPTACLES	= 2340							
	1 HVAC UNITS	= 13340							
	1 WATER HEATER	= 4800							
	0	_	watts						
	0	_	watts						
	0	_	watts						
	0	= 0	watts						

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DEALER:

PACIFIC MOBILE

DO-1130-2024 PMS

PROJECT: DO-1130

SERIAL NUMBERS:

WESTHOFF, TX

CLASSROOM

STATES:

DRAWN BY:

PLOT DATE:

REV # / DATE:

9/17/2025

TX


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STRUCTURES

PROJECT:

SHEET:

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Symbol	Type	Qty	Description
DUCTBOARD	Heat Duct	1	11x9 and 18x9 foil faced fiberglass, 1-1/2 in. thick (R-6.5)
	Metal Duct	1	Galvanized rectangle or round metal duct with insulation wrap (Min. R-6) and 24 ga. min. 1 in. wide straps with no holes (To meet SMACNA). See HVAC plan for sizes.
	Flex Duct	1	Flex duct. See HVAC plan for locations.
	Foilface Flex Duct	1	Foilface flex duct in fire reated areas. See HVAC plan for locations.
	Duct System	1	Plenum walls with fully ducted supply and return air
HVAC	HVAC Unit Type	5	36VP 3 Ton cooling with 10-KW electric end mount unit (Extend condensate to below bottom trim). W/CRV Color to be: (GRAY OR BEIGE)
HVAC	HVAC Unit Type	1	36VP 3 Ton cooling with 10-KW electric end mount unit (Extend condensate to below bottom trim). W/Economizer. Color to be: (GRAY OR BEIGE)
HVAC C	HVAC Unit Type	4	36VP 3 Ton cooling with 10-KW electric end mount unit with non-fusible disconnect (Extend condensate to below bottom trim). W/CRV Color to be: (GRAY OR BEIGE)
HVAC	HVAC Unit Type	1	36VP 3 Ton cooling with 10-KW electric end mount unit with non-fusible disconnect (Extend condensate to below bottom trim). Color to be: (GRAY OR BEIGE)
Û	T-Stat	10	Programmable T-Stat(s) (Honeywell 4000 series - TH4110U2005)
12	T-Stat	1	Programmable T-Stat(s) (Honeywell 6000 series - TH6220U2000)
SUPPLY BOOT	Supply Boot	11	(SB-2) first 4 ft. to be metal with insulation wrap (Min. R-6) connected to Bard unit and supply duct.
	Exhaust Fan	4	110 CFM ceiling mounted exhaust fan in T-grid
	Exhaust Fan	2	50 CFM ceiling mounted exhaust fan in T-grid
	Diffuser	62	24 in. x 24 in. 4-way lay-in diffuser with adjustable damper installed in T-grid ceiling
	R/A Grill	59	24 in. x 24 in. Perforated lay-in retrun air grill installed in T-grid ceiling
	Coupler	32	8 in. coupler at matelines for flex duct crossovers. (Shipped loose)
	Coupler	2	6 in. coupler at matelines for flex duct crossovers. (Shipped loose)
	Fitting	4	18 in. X 18 in. 45 degree elbow (E-6)
FD	Fire Damper	4	18 in. x 9 in. rectangular fire damper in the fire rated areas per plan. Min. 1 1/2 hour fire rated
FSD	Fire/Smoke Damper	9	6 in. round fire/smoke damper in the fire rated areas per plan. Min. 1 1/2 hour fire rated. w/ Integral smoke detector
$\boxtimes$	Inspection Port	9	6 in. x 12 in. inspection port in bottom of rectangle or round duct for fire/smoke dampers

MIN. 10 FEET HORIZONTALLY AWAY FROM ANY AIR INTAKE OPENING UNLESS IT IS AT LEAST 3 FEET ABOVE THE TOP OF SUCH OPENING. EXHAUST FAN SHALL TERMINATE THRU ROOF UNLESS OTHERWISE

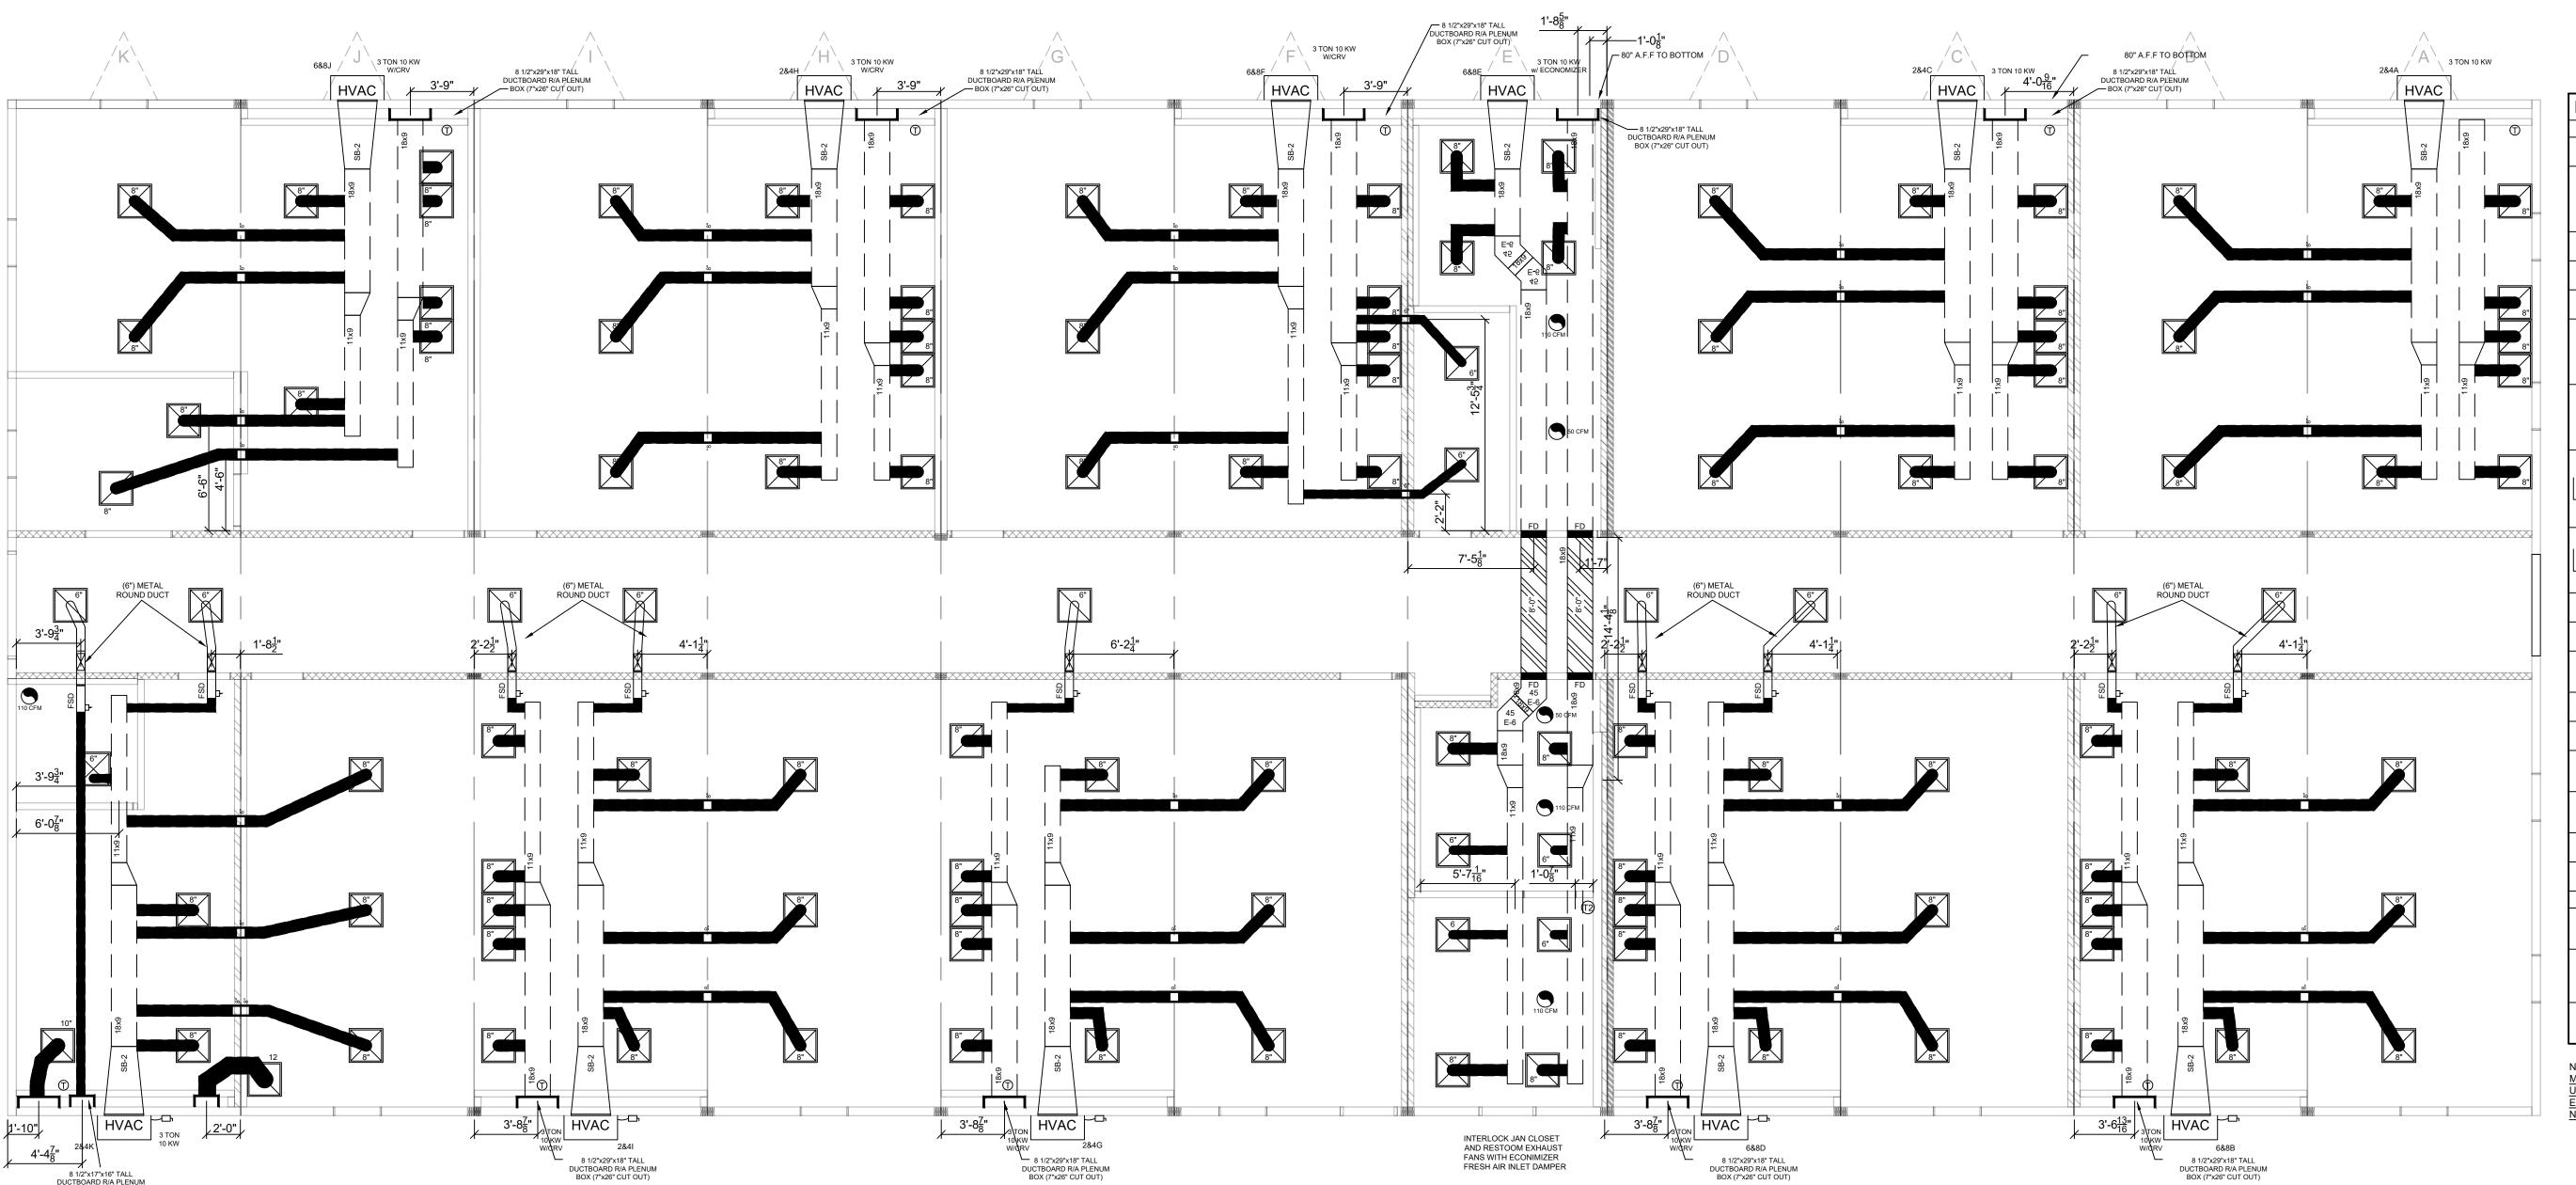HVAC PLAN

Vbz = (RP P2) + (Ra Az)									
AREA (Az) ROOM CLASSROOMS	<u>656</u> S.F.								
OCCUPANCY DENSITY LOAD #/1000 SQFT (P2)	35								
OUTSIDE AIR REQUIRED (RP) 10 CFM X 35 (P2)	350CFM								
AREA OUTDOOR AIRFLOW RATE (Ra <u>0.12</u> X (Az)	79CFM								
AIRFLOW RATE (Vbz)	429CFM								
TOTAL CFM AVAILABLE	1100CFM								
FRESH AIR DAMPER SETTING 429 / 1100	39%								

MECHANICAL VENTILATION

STANDARD WITH BARD UNIT IS A BAROMETRIC DAMPER WHICH PROVIDES UP TO 25% OF OUTSIDE FRESH AIR. A CRV REPLACES THE BAROMETRIC DAMPER AND THE CRV PROVIDES UP TO 50% OF OUTSIDE FRESH AIR.


\*MECHANICAL VENTILATION SHALL BE PROVIDED AS REQ'D. IN ACCORDANCE w/TABLE 403.3.1.1 OF THE IMC CODE OR NATURAL MEANS OF VENTILATION SHALL BE PROVIDED IN ACCORDANCE WITH SECTION 402 OF THE IMC CODE.

# HVAC GENERAL NOTE (CRV)

BARD HVAC UNITS WILL BE SHIPPED WITH THE CRV SET IN THE CLOSED POSITION BY IBI. THE CRV IS TO BE SET IN THE FIELD DURING SYSTEM BALANCING PER SITE CONDITIONS BY PACIFIC MOBILE STRUCTURES

## HVAC GENERAL NOTE (ECONOMIZER)

- SET ECONOMIZER ENTHALPY CONTROL ON "ES3".
- 2. SET ECONOMIZER DAMPERS TO 40% MINIMUM OPEN.

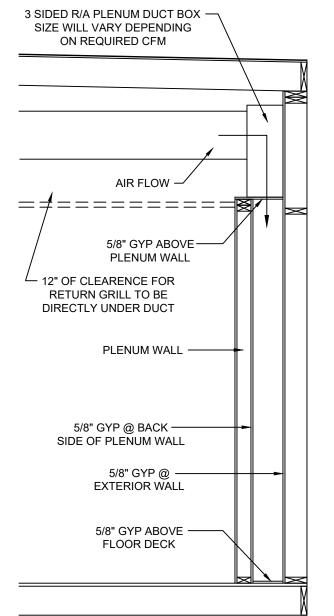

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PROJECT:

STATES:

PACIFIC MOBILE STRUCTURES

DO-1130-2024 PMS WESTHOFF, TX CLASSROOM

PROJECT: DO-1130

SERIAL NUMBERS:


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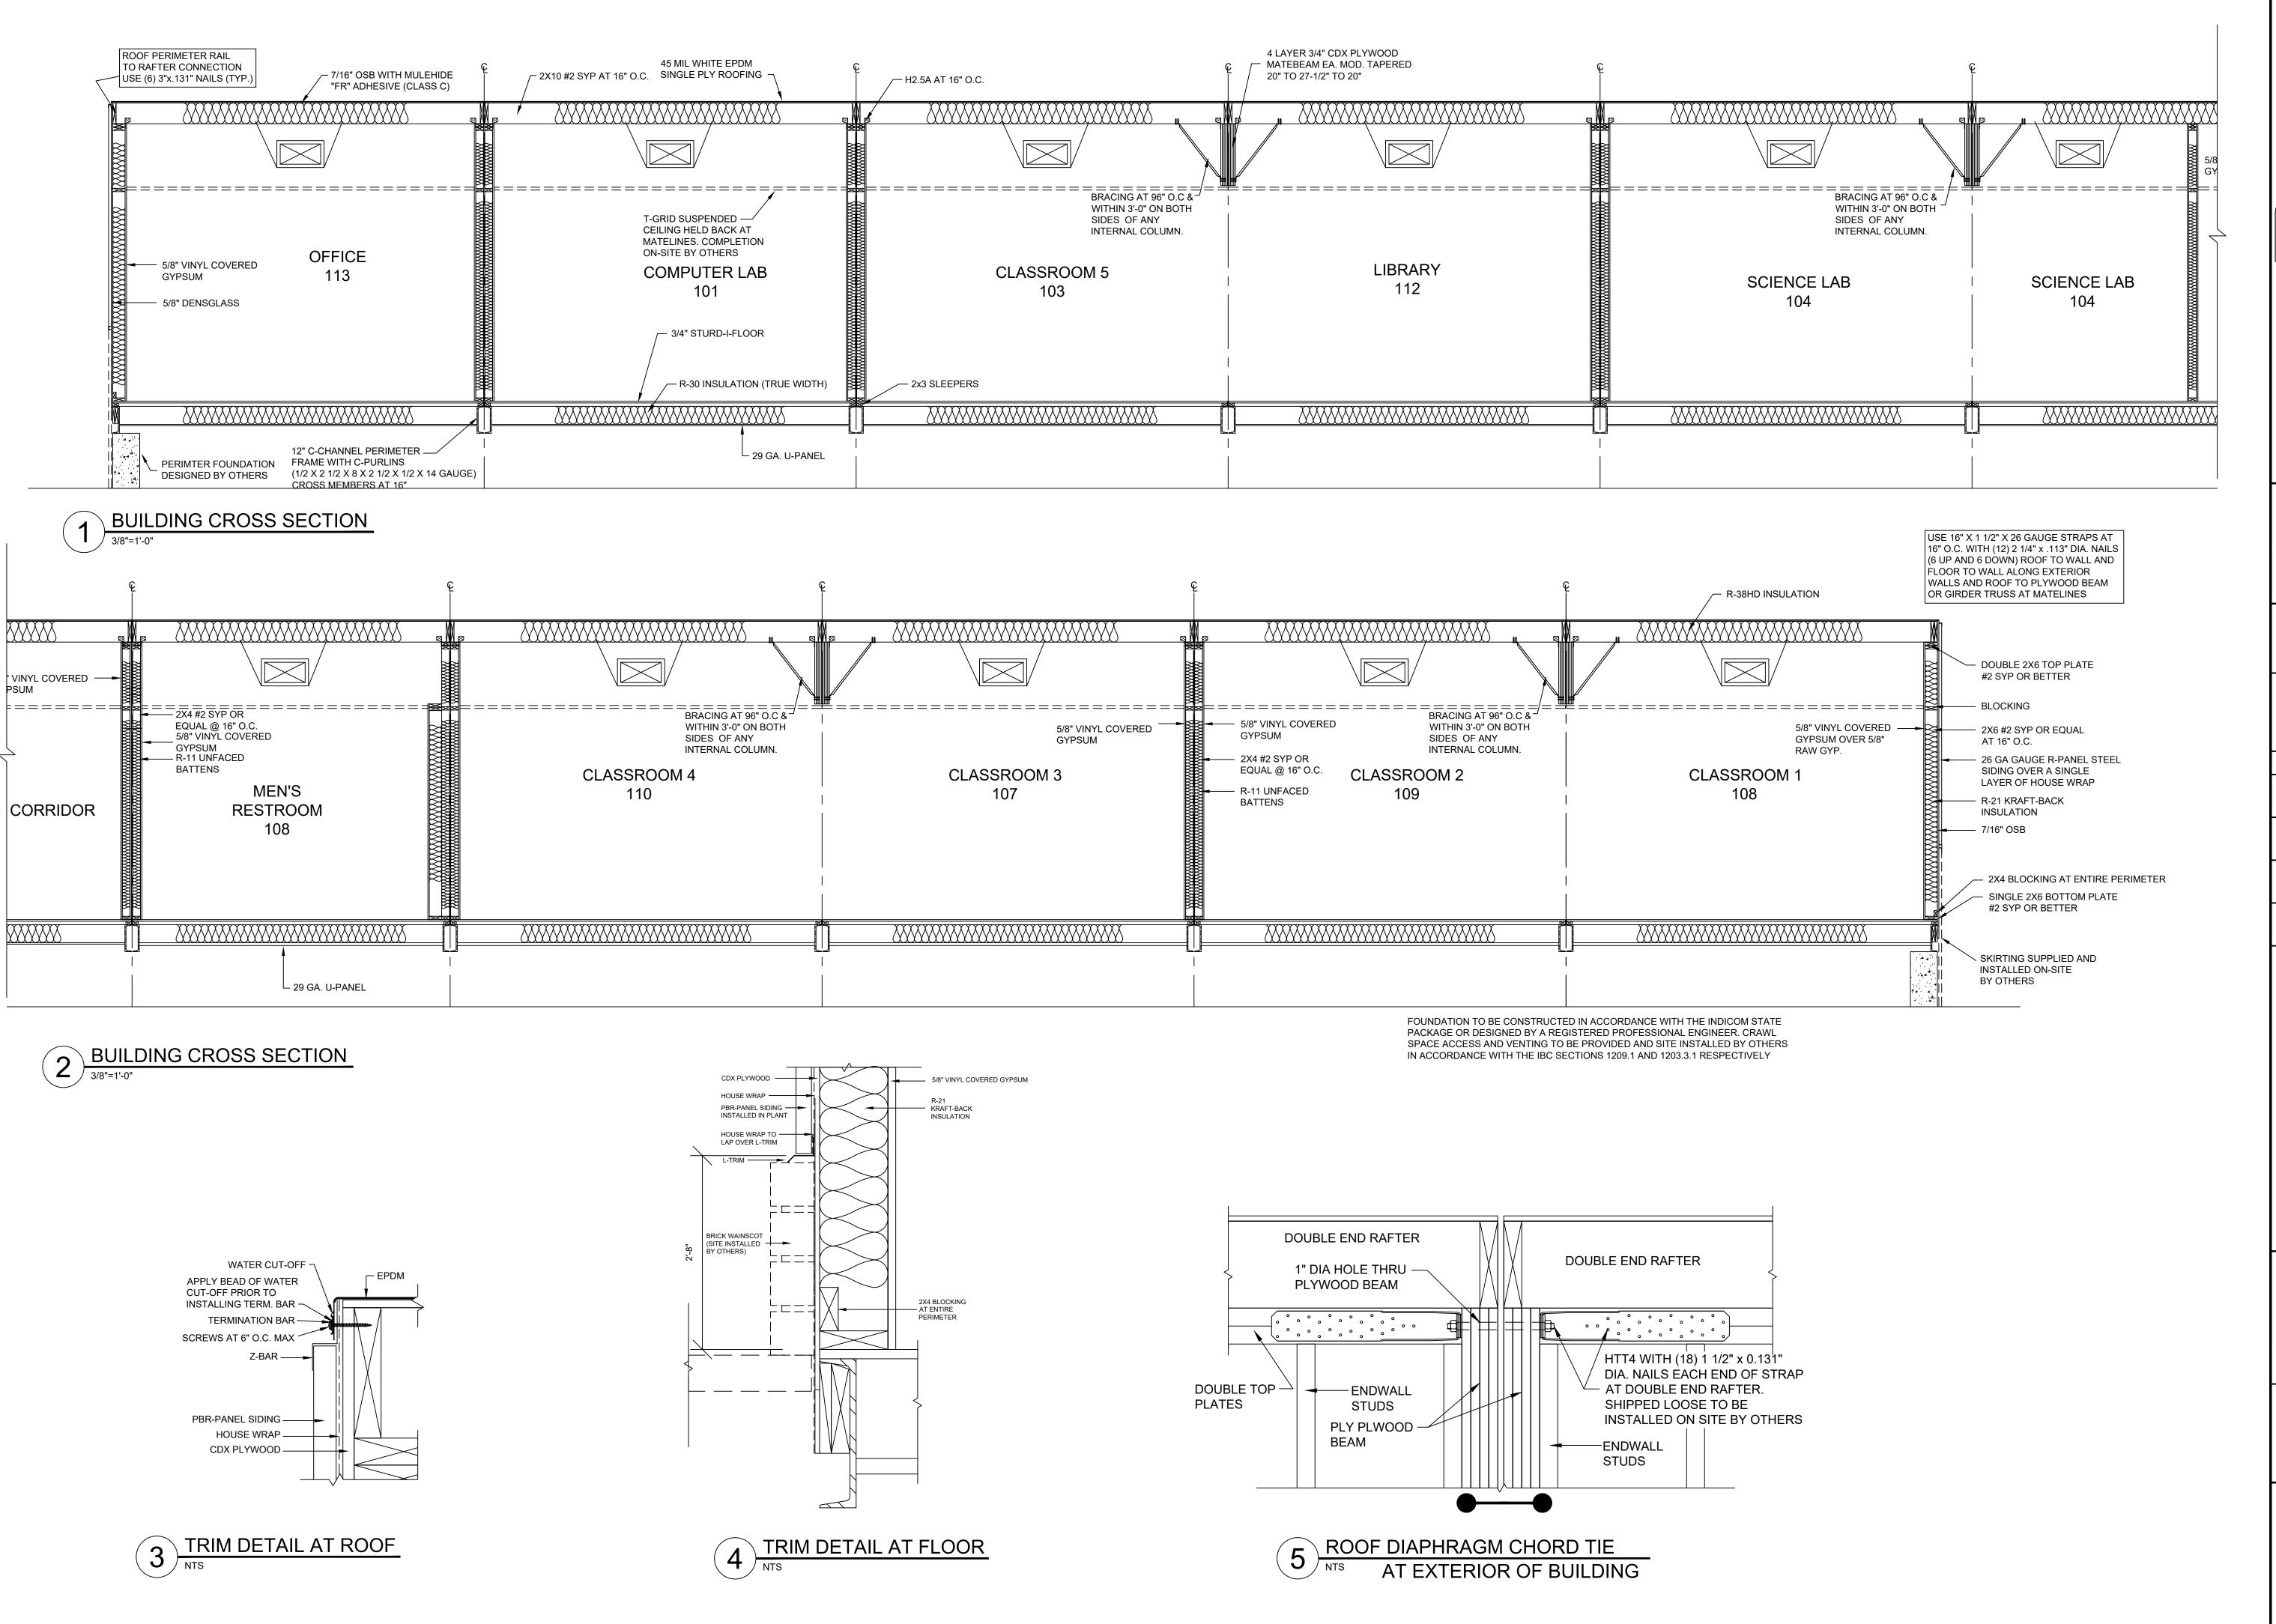
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WESTHOFF, TX
CLASSROOM

PROJECT: DO-1130
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TX

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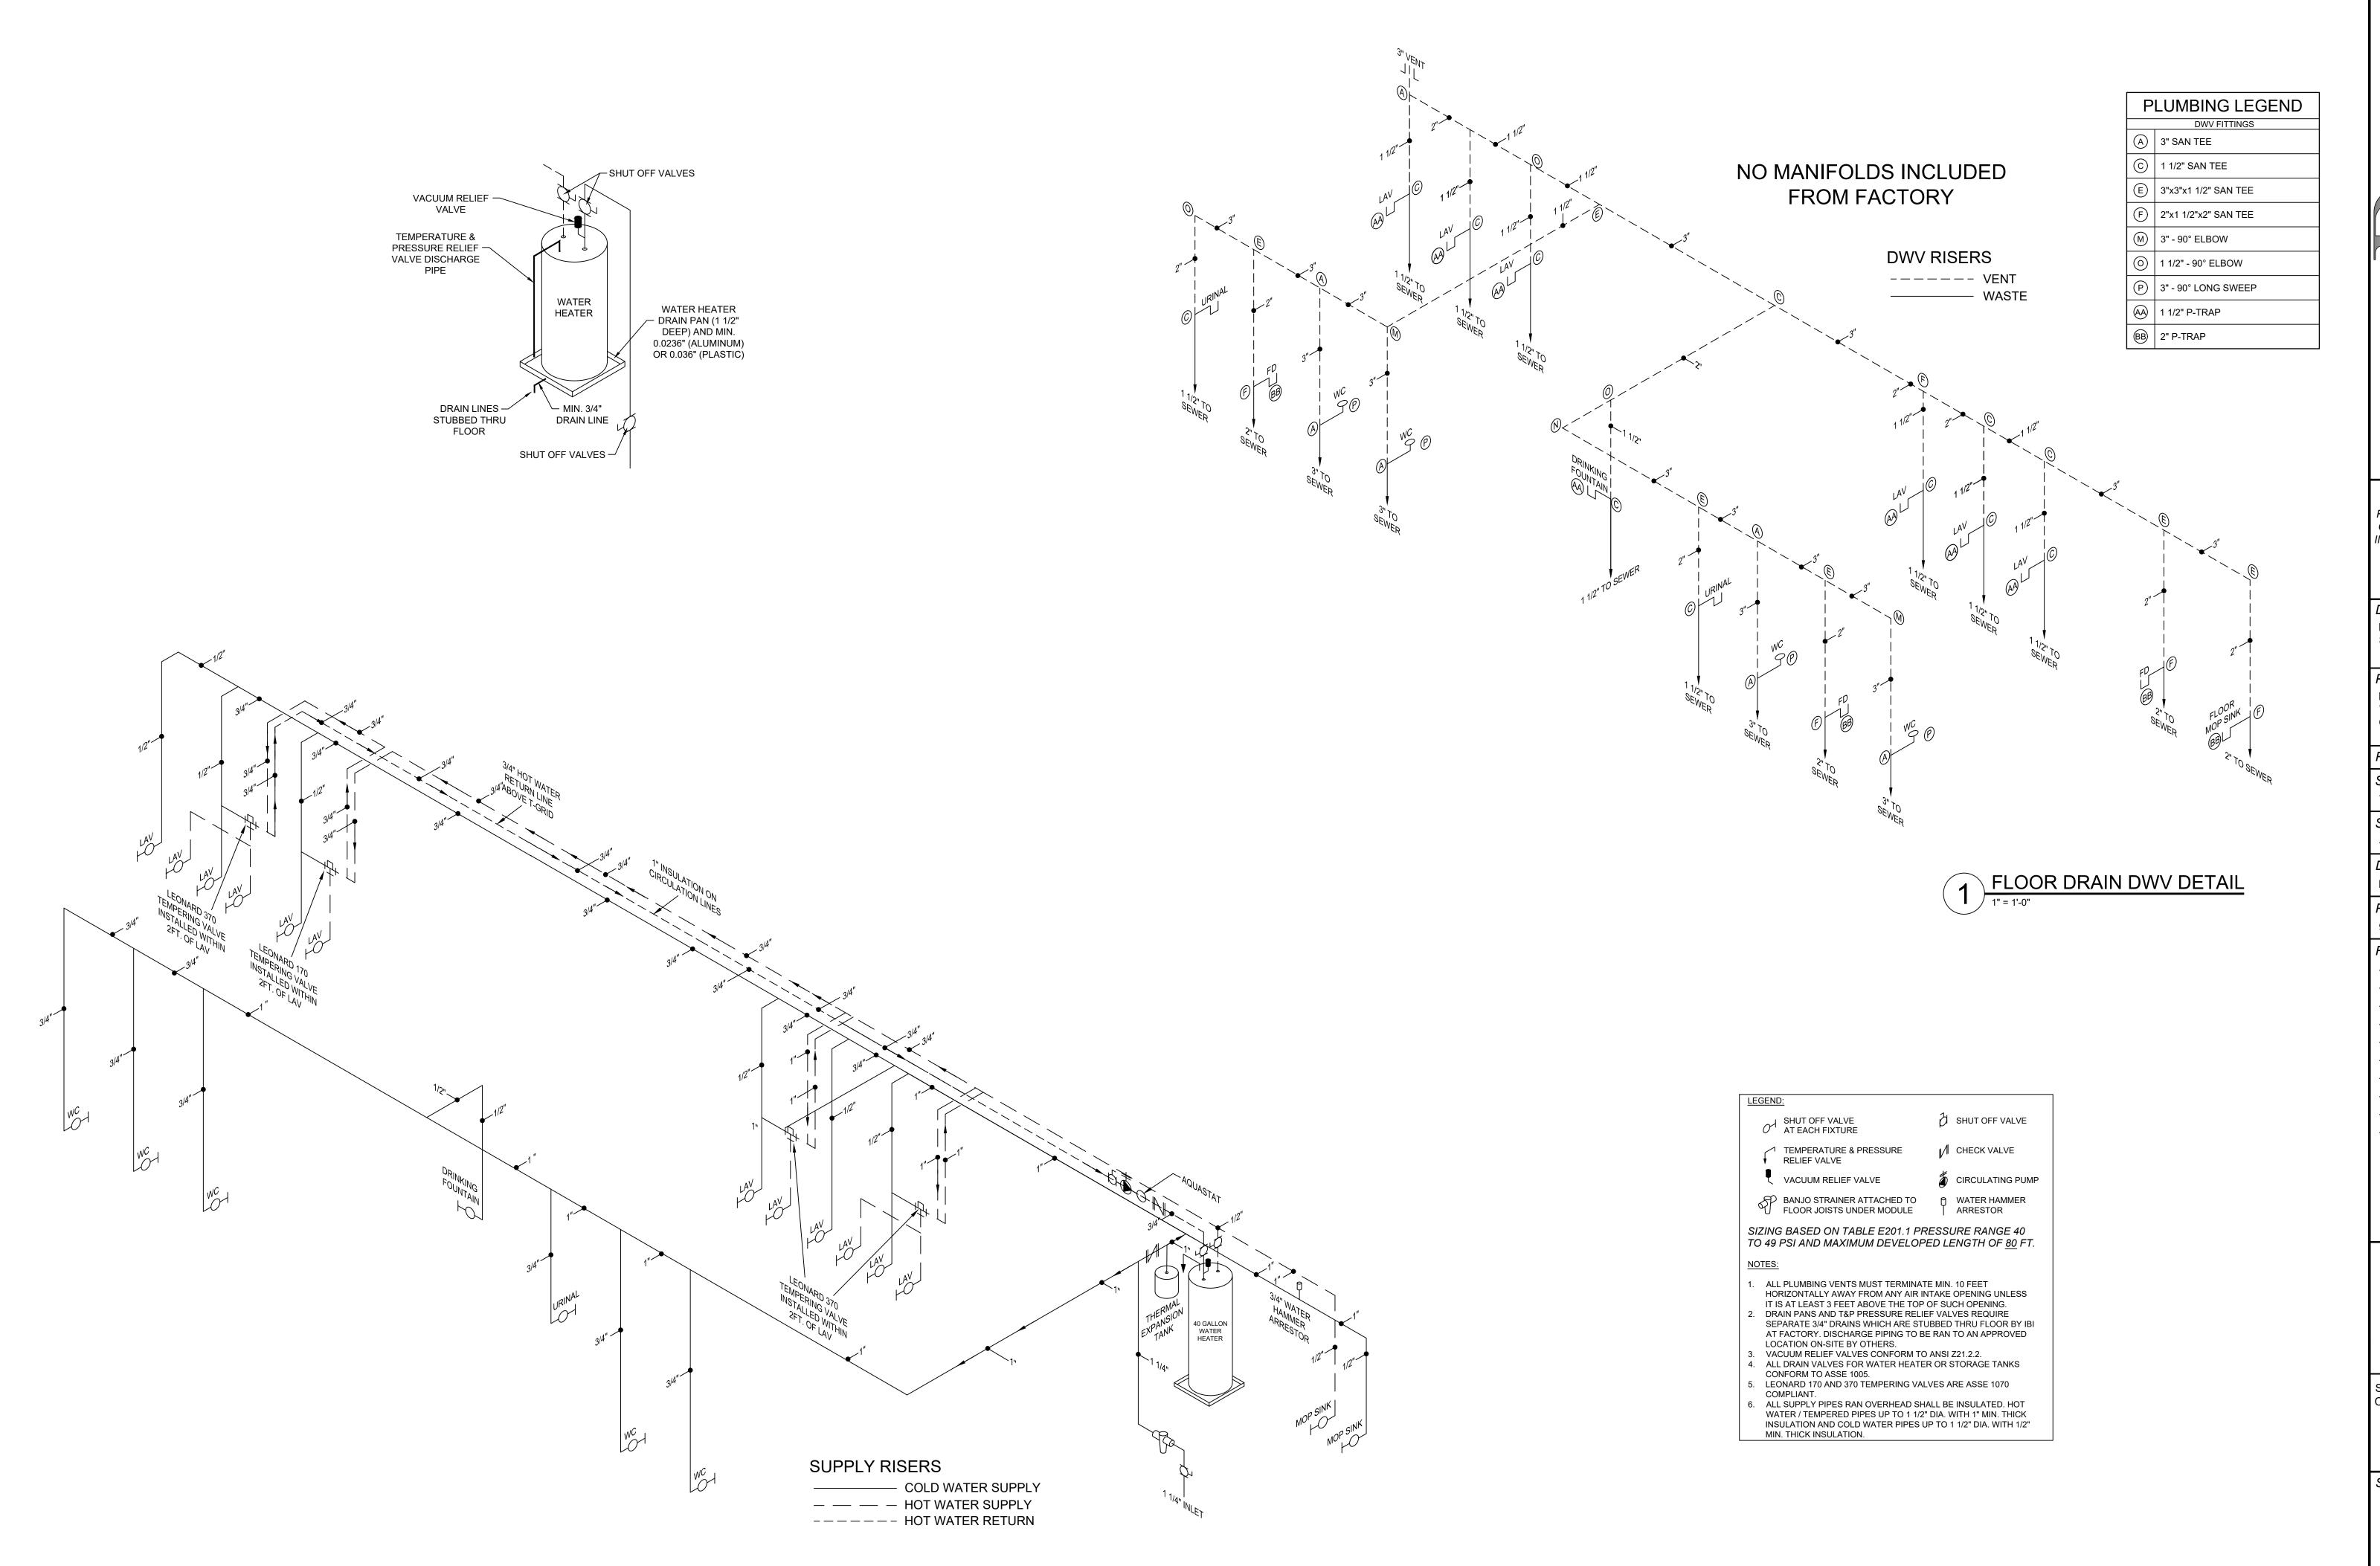
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**9** *OF* 



INDICOM BUILDINGS, INC
721 N. BURLESON BLVD - BURLESON, TX 76028
PH 817-447-1213 FAX 817-447-2751
SUNBELT MODULAR,
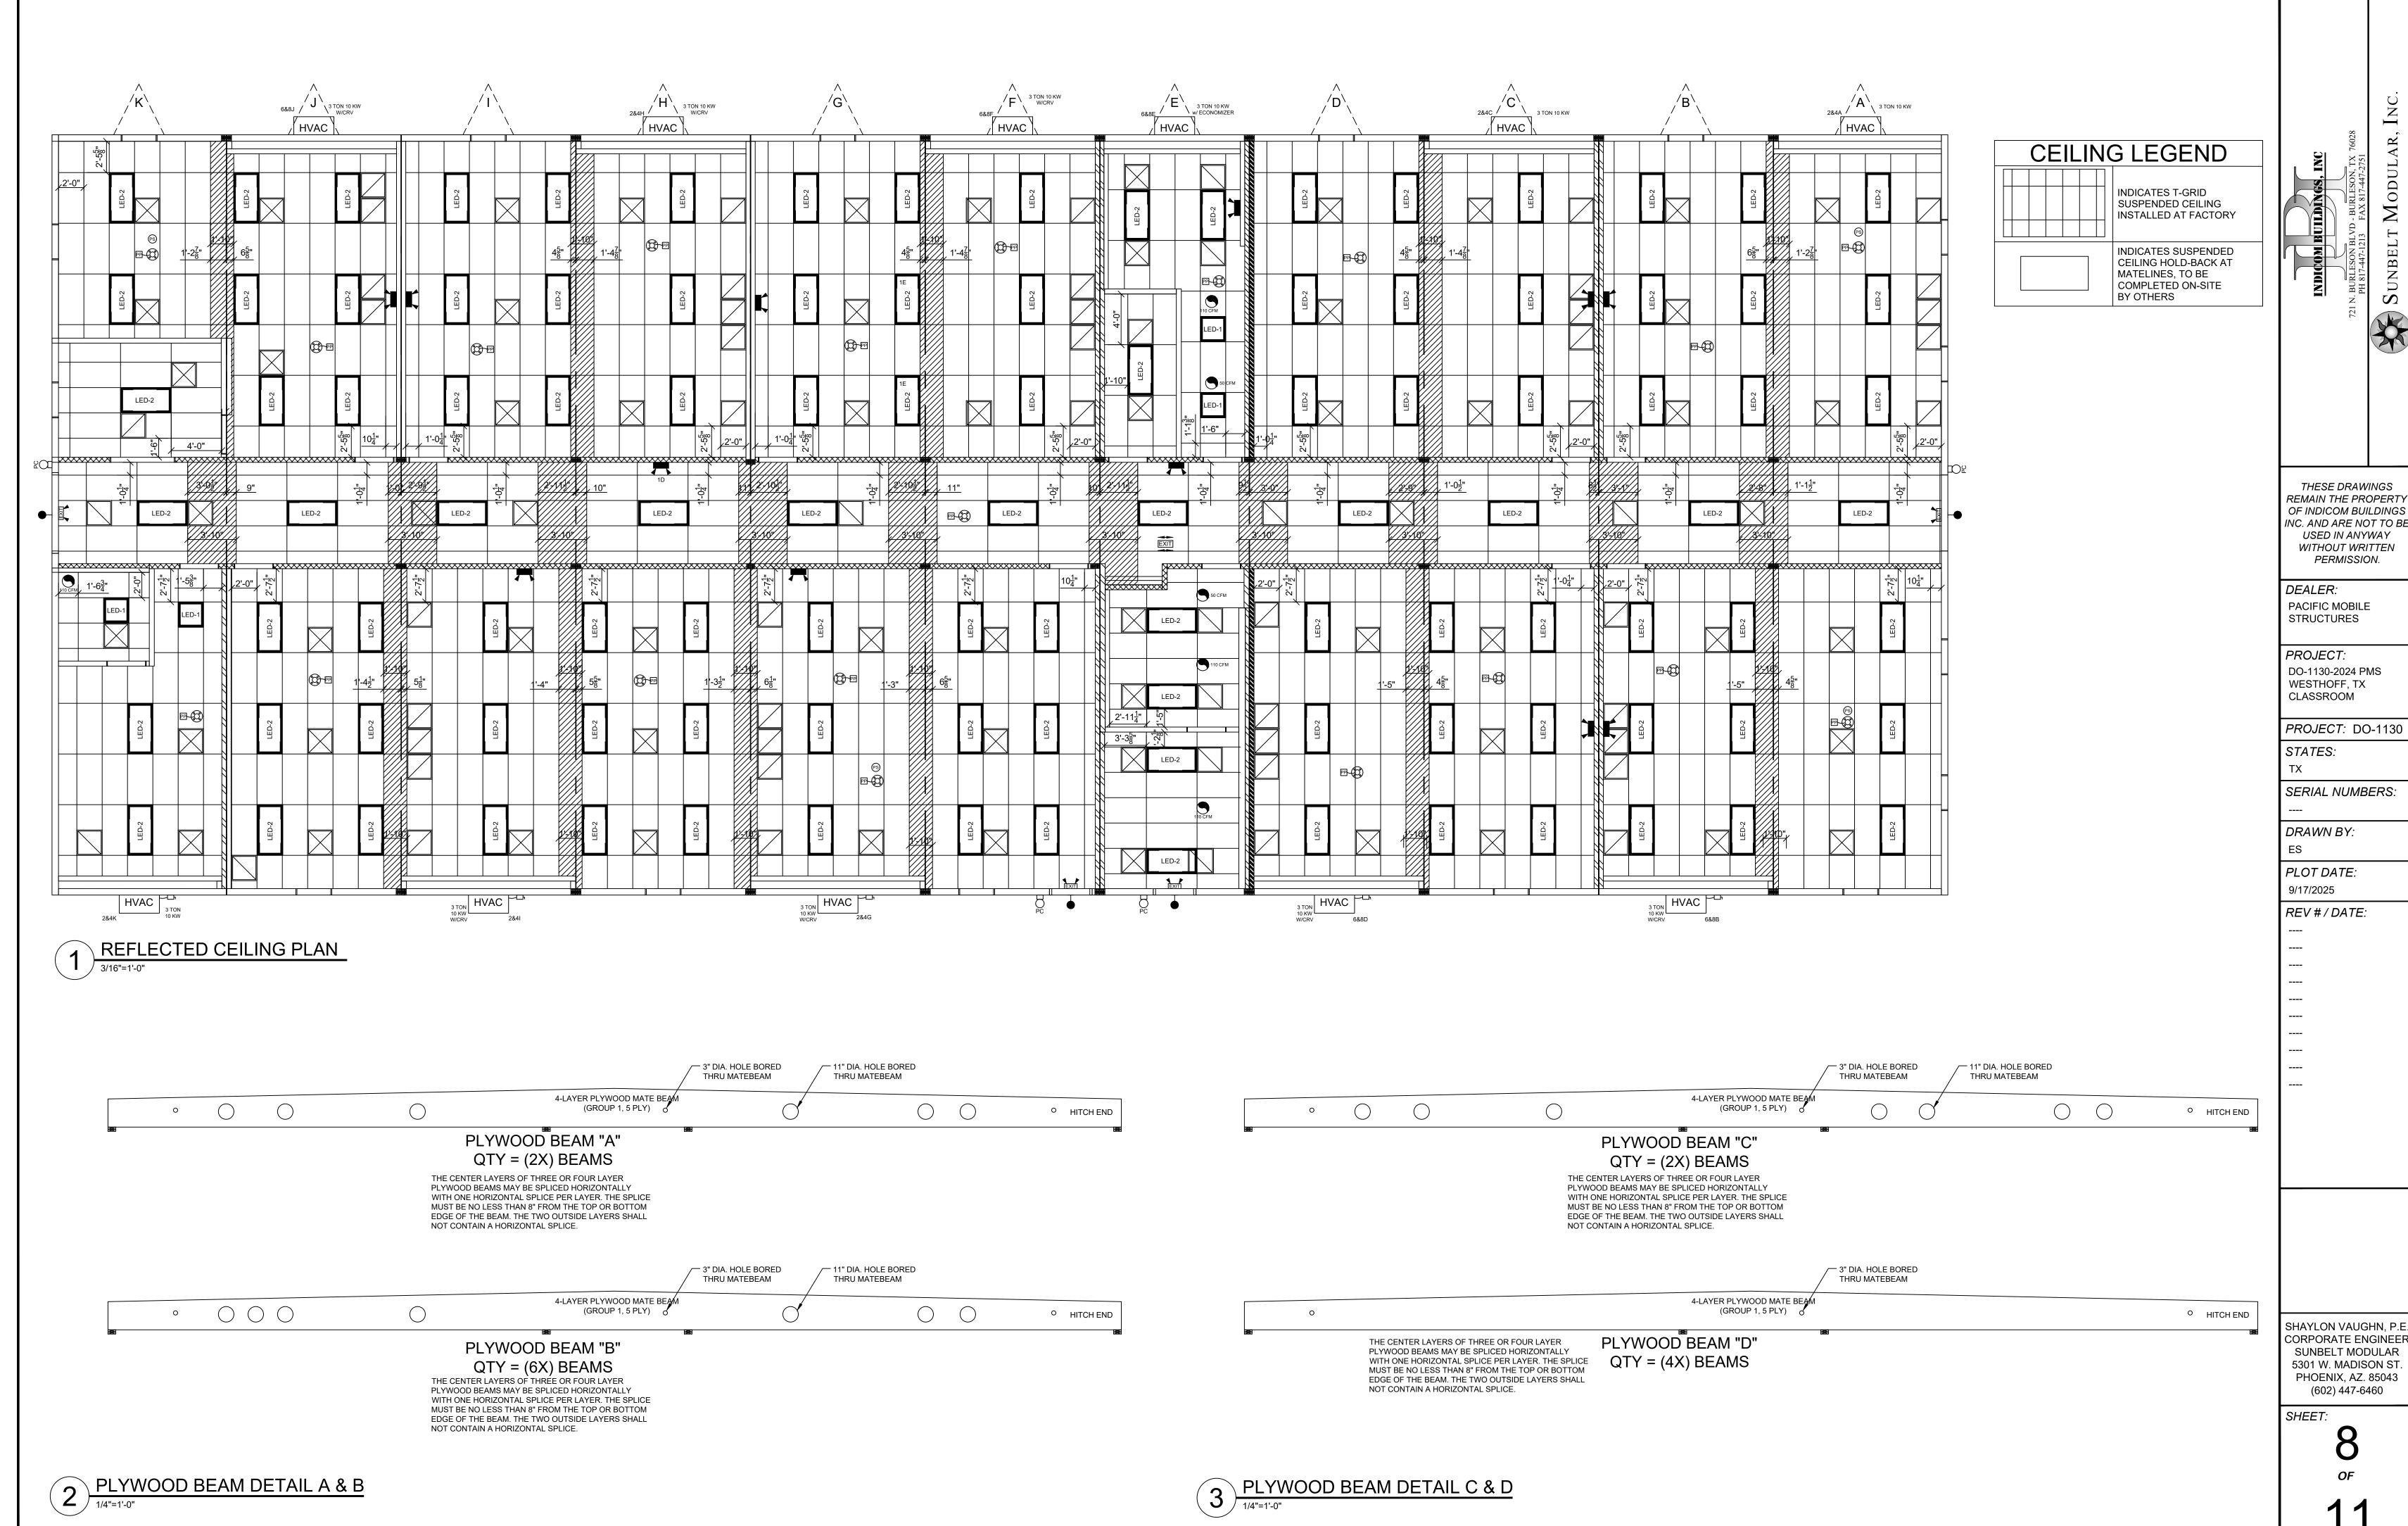
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DO-1130-2024 PMS
WESTHOFF, TX
CLASSROOM

PROJECT: DO-1130 STATES:

SERIAL NUMBERS:

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*PLOT DATE:* 9/17/2025

REV # / DATE:


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SHEET:

10 OF



1 SUGGESTED BLOCKING PLAN

1/4"=1'-0"

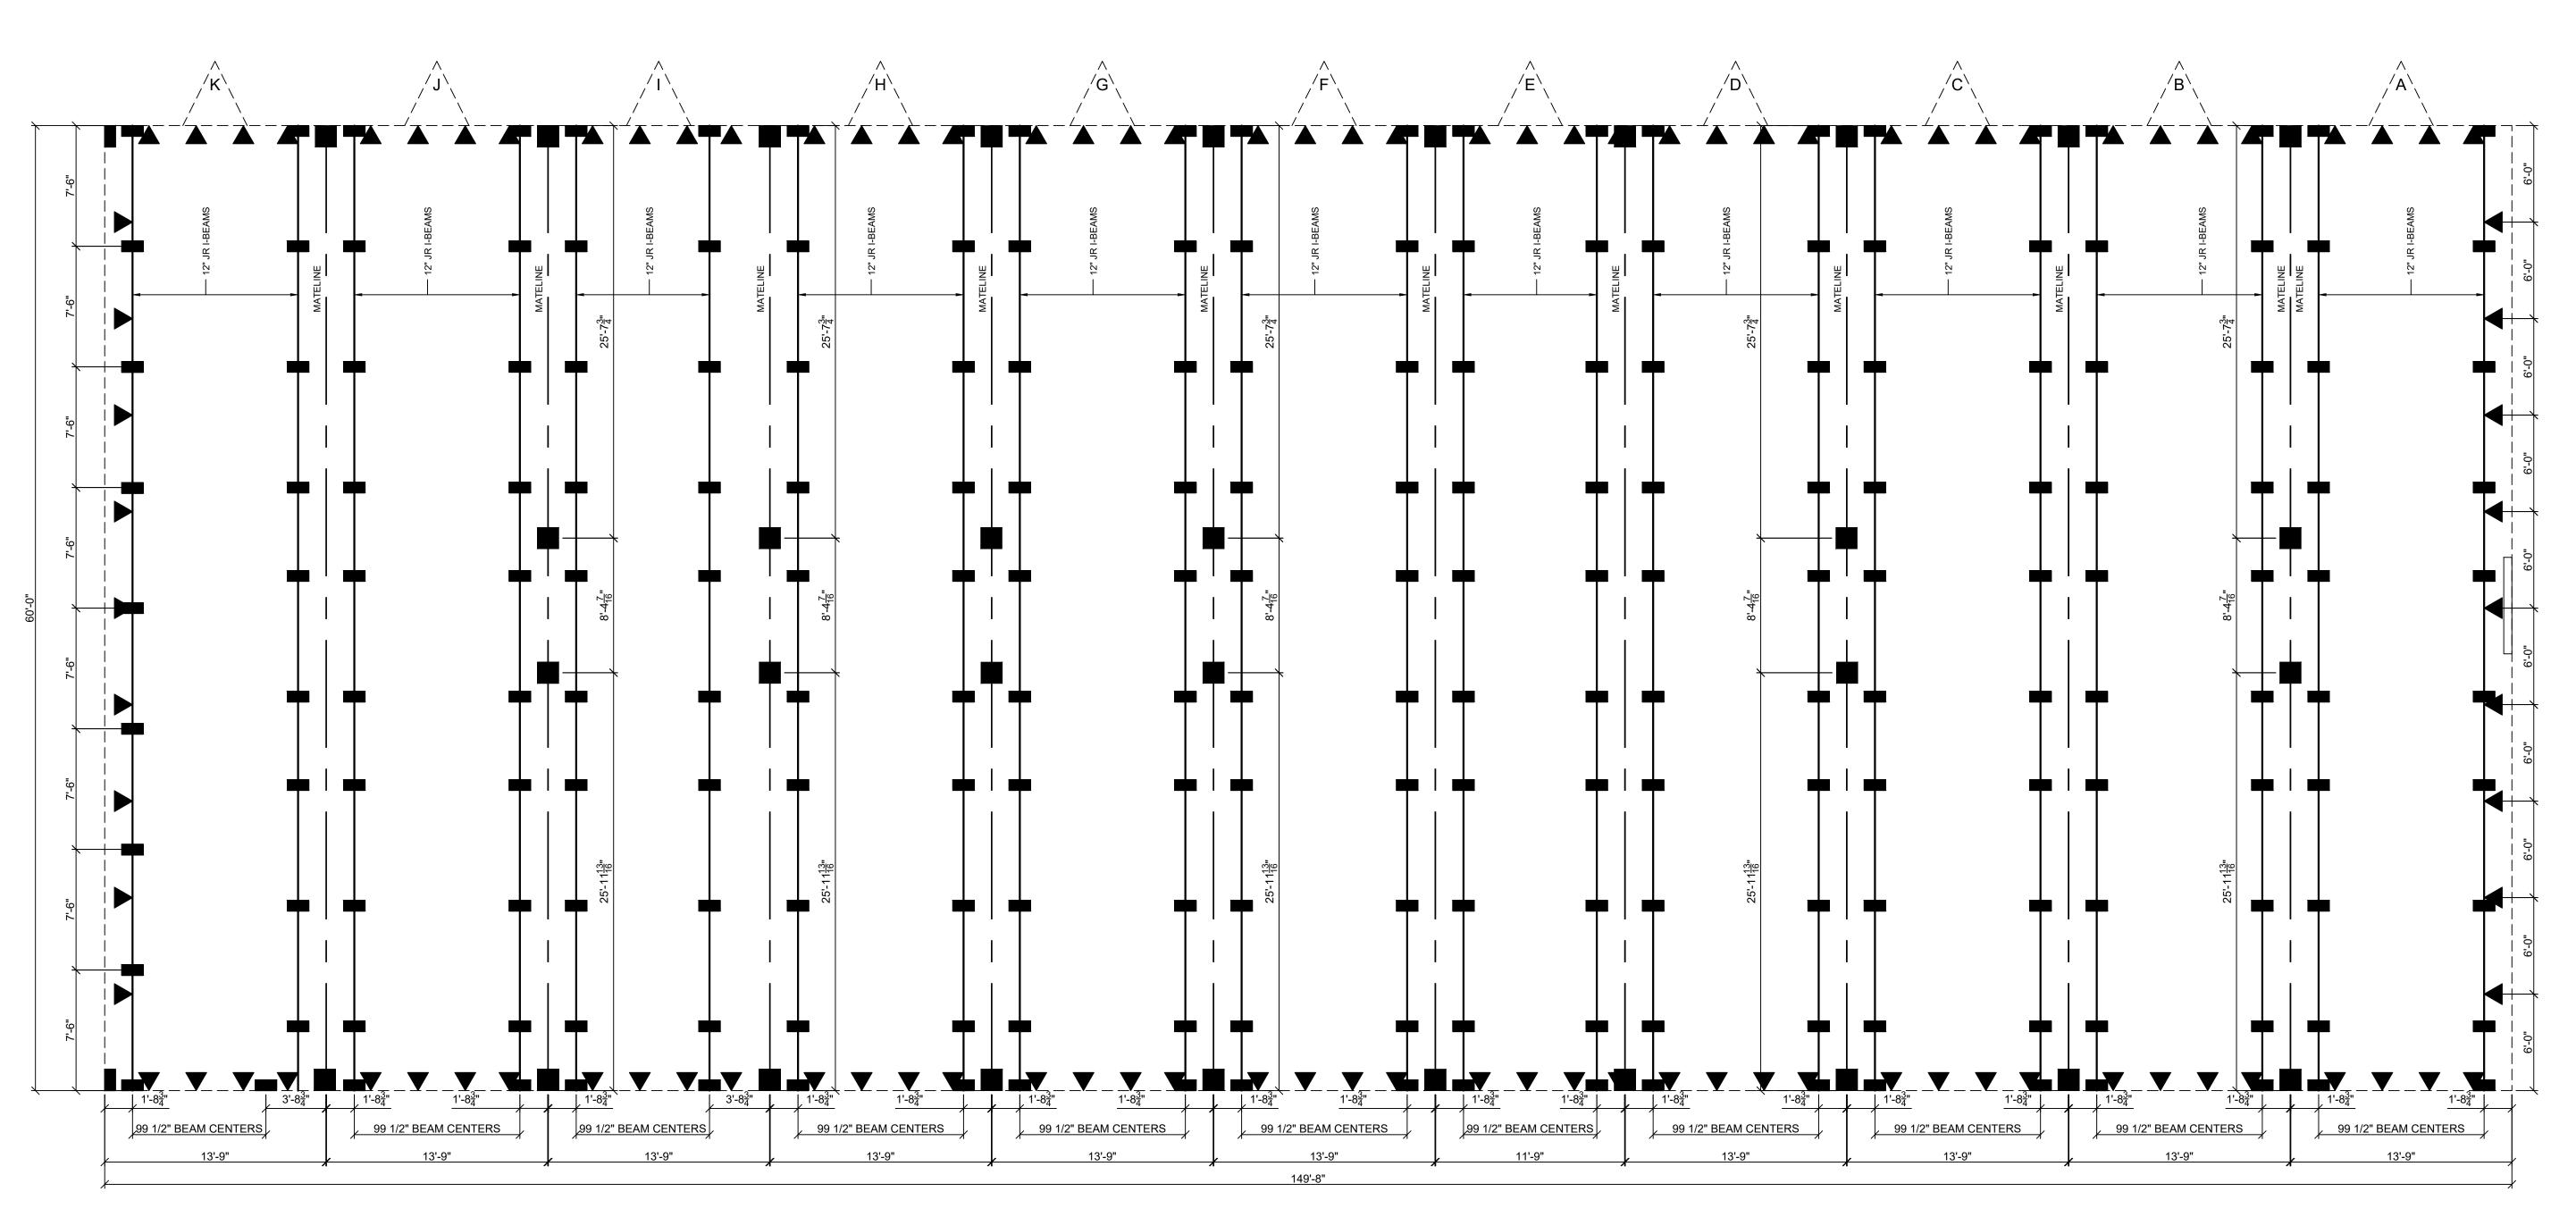CONCRETE SLAB ON GRADE

--- INDICATES SUGGESTED MAXIMUM I-BEAM BLOCKING SPACING - PIERS AND FOOTINGS DESIGNED BY LOCAL PROFESSIONAL IN ACCORD. WITH ALL LOCAL AND STATE REQUIREMENTS BASED ON SITE CONDITIONS.

--- INDICATES REQUIRED MATELINE BLOCKING LOCATION - PIERS AND FOOTINGS DESIGNED BY LOCAL PROFESSIONAL IN ACCORD. WITH ALL LOCAL AND STATE REQUIREMENTS BASED ON SITE CONDITIONS.

--- INDICATES REQUIRED FRAME-TIE GROUND ANCHOR (MIN. 4725 LBS. HOLDING STRENGTH) LOCATION FOR ALL WIND LOADS - NOTE: ALTERNATE ANCHORING DESIGN MAY BE MADE BY REGISTERED PROFESSIONAL ENGINEER.


THIS SUGGESTED BLOCKING PLAN IS PROVIDED FOR REFERENCE ONLY. THE NUMBER OF PIERS / TIEDOWNS AND THE SPACING SHOWN ARE BASED ON THE DESIGN CRITERIA LISTED ON THE COVER SHEET.


A SITE SPECIFIC FOUNDATION PLAN SHALL BE PROVIDED AND SEALED BY A LICENSED ENGINEER IN THE JURISDICTION HAVING AUTHORITY FOR EACH LOCATION THAT THIS BUILDING WILL BE LOCATED.

THE ACTUAL NUMBER OF PIERS / TIEDOWNS MAY DIFFER FROM WHAT IS SUGGESTED AS REQUIRED BY THE SITE SPECIFIC SOIL CONDITIONS AND THE FOUNDATION COMPONENTS SPECIFIED / DESIGNED BY THE LICENSED ENGINEER PROVIDING THE FINAL FOUNDATION PLAN.

HOWEVER THE MAXIMUM PIER SPACING SHALL NOT EXCEED 8'-0" ALONG THE FRAME MAIN RAILS / BEAMS.

THE ENGINER OF THE MODULAR BUILDING SHALL NOT BE HELD RESPONSIBLE FOR THE FOUNDATION DESIGN AND CONSEQUENTIAL PERFORMANCE OF THE OVERALL STRUCTURAL SYSTEM AND COMNPONENTS.

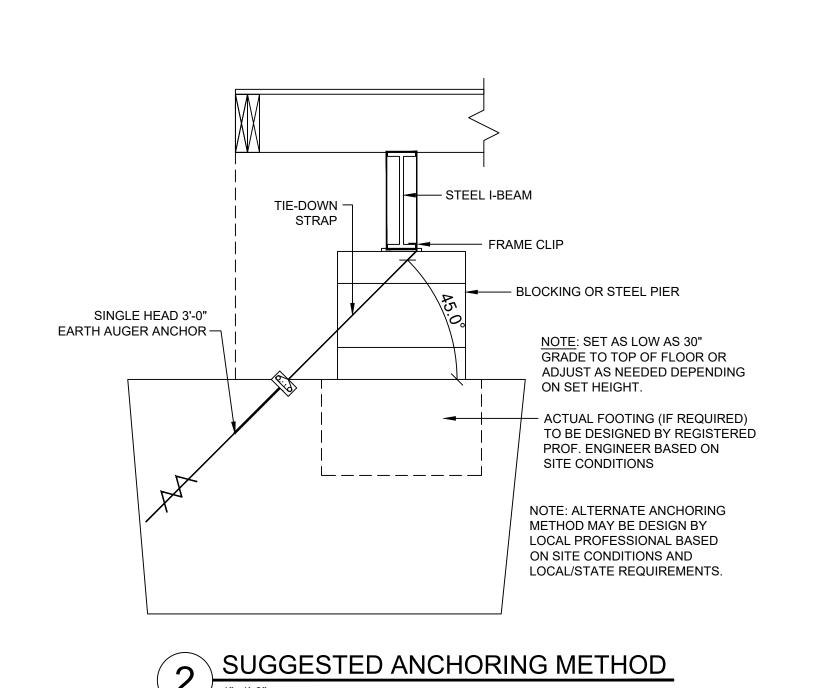

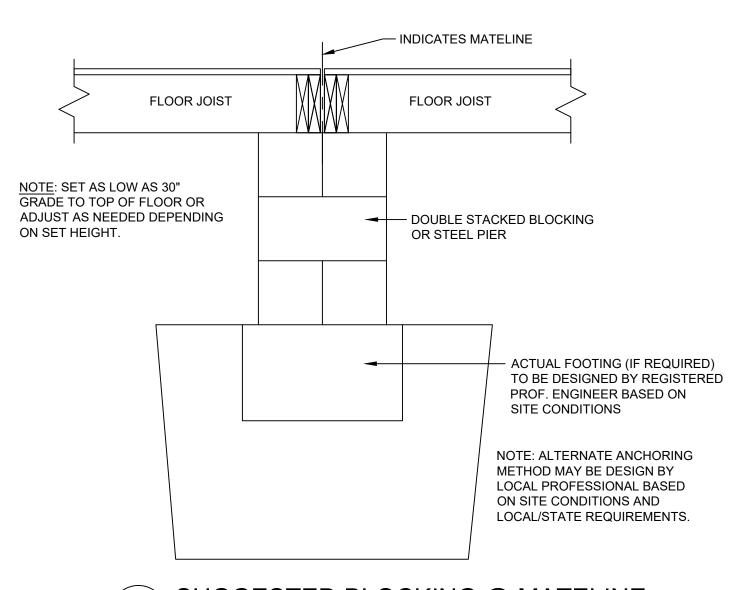

3 SUGGESTED BLOCKING @ MATELINE

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PACIFIC MOBILE

STRUCTURES

PROJECT:
DO-1130-2024 PMS
WESTHOFF, TX
CLASSROOM

PROJECT: DO-1130

STATES:

SERIAL NUMBERS:

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PLOT DATE:

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9/17/2025

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PHOENIX, AZ. 85043

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